

# **EXHIBIT B**




Approved by Phillip E Robbins  
Florida PE-49070  
*Phillip E Robbins*  
Plan No. 1RPER210076 Date: 03/27/2023

ND  
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DOCUMENT

## FASTENING SCHEDULE

DESCRIPTION OF BUILDING ELEMENT	NUMBER AND TYPE OF FASTENER	SPACING AND LOCATION
ROOF FRAMING		
1. BLOCKING BETWEEN CEILING JOISTS OR RAFTERS TO TOP PLATE OR OTHER FRAMING.	3 - 8d COMMON (2 $\frac{1}{2}$ " x 0.131") 3 - 10d BOX (3" x 0.128") 3 - 3" x 0.131" NAILS 3 - 3" 14 GAGE STAPLES, $\frac{1}{16}$ " CROWN	EACH END, TOENAIL
2. BLOCKING BETWEEN RAFTERS NOT AT THE WALL TOP PLATE, TO RAFTER.	2 - 8d COMMON (2 $\frac{1}{2}$ " x 0.131") 2 - 3" x 0.131" NAILS 2 - 3" 14 GAGE STAPLES  2 - 16d COMMON (3 $\frac{1}{2}$ " x 0.162") 3 - 3" x 0.131" NAILS 3 - 3" 14 GAGE STAPLES	EACH END, TOENAIL  END NAIL
COLLAR TIE TO RAFTER	REFERENCE SHEETS S-2.4 AND S-2.5	
RAFTER OR ROOF TRUSS TO TOP PLATE	3 - 10d COMMON (3" x 0.148") 3 - 16d BOX (3 $\frac{1}{2}$ " x 0.135") 4 - 10d BOX (3" x 0.128") 4 - 3" x 0.131" NAILS 4 - 3" 14 GAGE STAPLES, $\frac{1}{16}$ " CROWN	TOENAIL <sup>b</sup>
CEILING JOISTS TO TOP PLATE	3 - 8d COMMON (2 $\frac{1}{2}$ " x 0.131") 3 - 10d BOX (3" x 0.128") 3 - 3" x 0.131" NAILS 3 - 3" 14 GAGE STAPLES, $\frac{1}{16}$ " CROWN	EACH JOIST. TOENAIL
WALL FRAMING		
STUD TO STUD (NOT AT BRACED WALL PANELS)	16d COMMON (3 $\frac{1}{2}$ " x 0.162")	24" O.C. FACE NAIL
	10d BOX (3" x 0.128") 3" x 0.131" NAILS 3 - 3" 14 GAGE STAPLES	16" O.C. FACE NAIL
STUD TO STUD AND ABUTTING STUDS AT INTERSECTING WALL CORNERS (AT BRACED WALL PANELS)	16d COMMON (3 $\frac{1}{2}$ " x 0.162")	16" O.C. FACE NAIL
	16d BOX (3 $\frac{1}{2}$ " x 0.135")  3" x 0.131" NAILS 3 - 3" 14 GAGE STAPLES, $\frac{1}{16}$ " CROWN	12" O.C. FACE NAIL  12" O.C. FACE NAIL
	3" x 0.131" NAILS 3 - 3" 14 GAGE STAPLES, $\frac{1}{16}$ " CROWN	12" O.C. FACE NAIL
CONTINUOUS HEADER TO STUD	4 - 8d COMMON (2 $\frac{1}{2}$ " x 0.131") 4 - 10d BOX (3" x 0.128")	TOENAIL
TOP PLATE TO TOP PLATE	16d COMMON (3 $\frac{1}{2}$ " x 0.162")	16" O.C. FACE NAIL
	10d BOX (3" x 0.128") 3" x 0.131" NAILS 3 - 3" 14 GAGE STAPLES, $\frac{1}{16}$ " CROWN	12" O.C. FACE NAIL

DESCRIPTION OF BUILDING ELEMENT	NUMBER AND TYPE OF FASTENER	SPACING AND LOCATION
WALL FRAMING (CONT.)		
TOP PLATE TO TOP PLATE, AT END JOINTS	8 - 16d COMMON (3 $\frac{1}{2}$ " x 0.162") 12 - 10d BOX (3" x 0.128") 12 - 3" x 0.131" NAILS 12 - 3" 14 GAGE STAPLES, $\frac{1}{16}$ " CROWN	EACH SIDE OF END JOINT, FACE NAIL (MINIMUM 24" LAP SPLICE LENGTH EACH SIDE OF END JOINT)
BOTTOM PLATE TO JOIST, RIM JOIST, BAND JOIST, OR BLOCKING (NOT AT BRACED WALL PANELS)	16d COMMON (3 $\frac{1}{2}$ " x 0.162")  16d BOX (3 $\frac{1}{2}$ " x 0.135") 3" x 0.131" NAILS 3" 14 GAGE STAPLES, $\frac{1}{16}$ " CROWN	16" O.C. FACE NAIL  12" O.C. FACE NAIL
BOTTOM PLATE TO JOIST, RIM JOIST, BAND JOIST, OR BLOCKING (AT BRACED WALL PANELS)	2 - 16d COMMON (3 $\frac{1}{2}$ " x 0.162") 3 - 16d BOX (3 $\frac{1}{2}$ " x 0.135") 4 - 3" x 0.131" NAILS 4 - 3" 14 GAGE STAPLES, $\frac{1}{16}$ " CROWN	16" O.C. FACE NAIL
STUD TO TOP OR BOTTOM PLATE	4 - 8d COMMON (2 $\frac{1}{2}$ " x 0.131") 4 - 10d BOX (3" x 0.128") 4 - 3" x 0.131" NAILS 4 - 3" 14 GAGE STAPLES, $\frac{1}{16}$ " CROWN	TOENAIL
	2 - 16d COMMON (3 $\frac{1}{2}$ " x 0.162") 3 - 10d BOX (3" x 0.128") 3 - 3" x 0.131" NAILS 3 - 3" 14 GAGE STAPLES, $\frac{1}{16}$ " CROWN	END NAIL
TOP PLATES, LAPS AT CORNERS AND INTERSECTIONS	2 - 16d COMMON (3 $\frac{1}{2}$ " x 0.162") 3 - 10d BOX (3" x 0.128") 3 - 3" x 0.131" NAILS 3 - 3" 14 GAGE STAPLES, $\frac{1}{16}$ " CROWN	FACE NAIL
FLOOR FRAMING		
JOIST TO SKID	3 - 8d COMMON (2 $\frac{1}{2}$ " x 0.131") 3 - 10d BOX (3" x 0.128") 3 - 3" x 0.131" NAILS 3 - 3" 14 GAGE STAPLES, $\frac{1}{16}$ " CROWN	TOENAIL
BUILT-UP BEAMS	10d BOX (3" x 0.128") 3" x 0.131" NAILS 3" 14 GAGE STAPLES, $\frac{1}{16}$ " CROWN	24" O.C. FACE NAIL AT TOP AND BOTTOM STAGGERED ON OPPOSITE SIDES
	AND: 3 - 10d BOX (3" x 0.128") 3 - 3" x 0.131" NAILS 3 - 3" 14 GAGE STAPLES, $\frac{1}{16}$ " CROWN	ENDS AND AT EACH SPLICE, FACE NAIL
JOIST TO BAND JOIST OR RIM JOIST	3 - 16d COMMON (3 $\frac{1}{2}$ " x 0.162") 4 - 10d BOX (3" x 0.128") 4 - 3" x 0.131" NAILS 4 - 3" 14 GAGE STAPLES, $\frac{1}{16}$ " CROWN	END NAIL

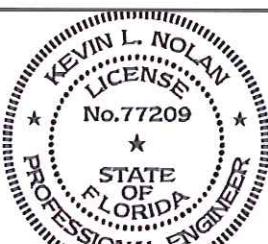

LOFTED BARN--FLORIDA--WIND=160 MPH--FBC 2020

Digitally signed by Kevin Nolan  
DN:  
0.9.2342.19200300.100.1.1=A01410C0000  
0179D834EF80000196AF, cn=Kevin  
Nolan, c=US  
Date: 2023.03.22 13:44:53 -05'00'

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**Weather King<sup>®</sup>**  
PORTABLE BUILDINGS

PROJECT NO:

DATE: 09-28-2021

DRAWN BY: KLN

CHECKED BY: KLN

REVISION:

SHEET NUMBER

S-01-LB

SCALE: NONE

## FASTENING SCHEDULE (CONT.)

DESCRIPTION OF BUILDING ELEMENT	NUMBER AND TYPE OF FASTENER	SPACING AND LOCATION	
SUBFLOOR, ROOF AND INTERIOR WALL SHEATHING <sup>a</sup>			
		EDGES (INCHES)	INTERMEDIATE SUPPORTS (INCHES)
$\frac{1}{2}''$ TO $\frac{3}{4}''$	6d COMMON OR DEFORMED (2" x 0.113") (SUBFLOOR AND WALL)	6	12
	8d COMMON OR DEFORMED (2 $\frac{1}{2}$ " x 0.131") (ROOF)	6	12
	2 $\frac{1}{2}$ " x 0.113" NAIL (SUBFLOOR AND WALL)	6	12
	1 $\frac{1}{4}$ " 16 GAGE STAPLE, $\frac{1}{8}$ " CROWN (SUBFLOOR AND WALL)	4	8
	2 $\frac{1}{2}$ " x 0.113" RING SHANK NAIL (ROOF)	6	12
	1 $\frac{1}{4}$ " 16 GAGE STAPLE, $\frac{1}{8}$ " CROWN (ROOF)	3	6
$\frac{3}{4}''$ TO $\frac{5}{8}''$	8d COMMON (2 $\frac{1}{2}$ " x 0.131") 6d DEFORMED (2" x 0.113") (SUBFLOOR AND WALL)	6	12
	2 $\frac{1}{2}$ " x 0.113" RING SHANK NAIL	6	12
EXTERIOR WALL SIDING			
$\frac{3}{4}''$ LP SMARTSIDE PRECISION PANEL OR $\frac{3}{4}''$ TREATED T1-11 SIDING	2 $\frac{1}{2}$ " x 0.113" RING SHANK NAIL	6 (SIDE WALL)	6
	2 $\frac{1}{2}$ " x 0.113" RING SHANK NAIL	3 (END WALL)	6

a. NAILS SPACED AT 6 INCHES AT INTERMEDIATE SUPPORTS WHERE SPANS ARE 48 INCHES OR MORE. NAILS FOR WALL SHEATHING ARE PERMITTED TO BE COMMON, BOX, OR CASING.  
 b. WHERE A RAFTER IS FASTENED TO AN ADJACENT PARALLEL CEILING JOIST IN ACCORDANCE WITH THIS SCHEDULE AND THE CEILING JOIST IS FASTENED TO THE TOP PLATE IN ACCORDANCE WITH THIS SCHEDULE, THE NUMBER OF TOENAILS IN THE RAFTER SHALL BE PERMITTED TO BE REDUCED BY ONE NAIL.

Approved by Phillip E Robbins  
 Florida PE-49070  
 Phillip E Robbins  
 Plan No. 1RPER210076 Date: 03/27/2023

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LOFTED BARN--FLORIDA--WIND=160 MPH--FBC 2020

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 DN:  
 0.9.2342.19200300.100.1.1=A01410C000  
 00179D834EF80000196AF, cn=Kevin  
 Nolan, c=US  
 Date: 2023.03.22 13:45:13-05'00'

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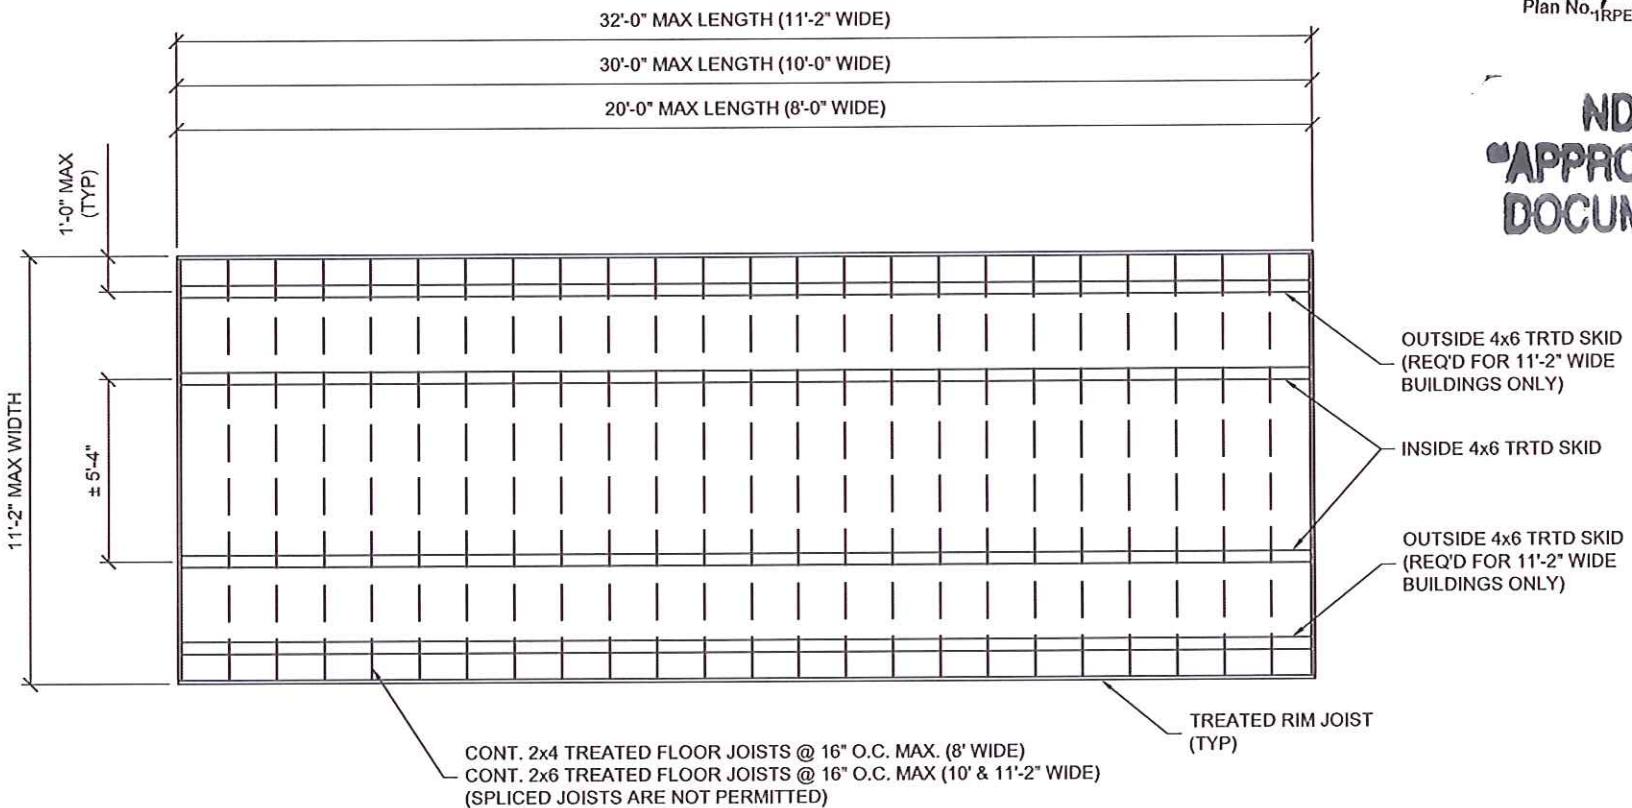
SHEET NUMBER

**S-02-LB**

SCALE: NONE

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Florida PE-49070  
*Phillip E Robbins*  
Plan No. 1RPER210076 Date: 03/27/2023

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TYPICAL FLOOR FRAMING PLAN



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Nolan, c=US  
Date: 2023.03.22 13:45:32 -05'00'

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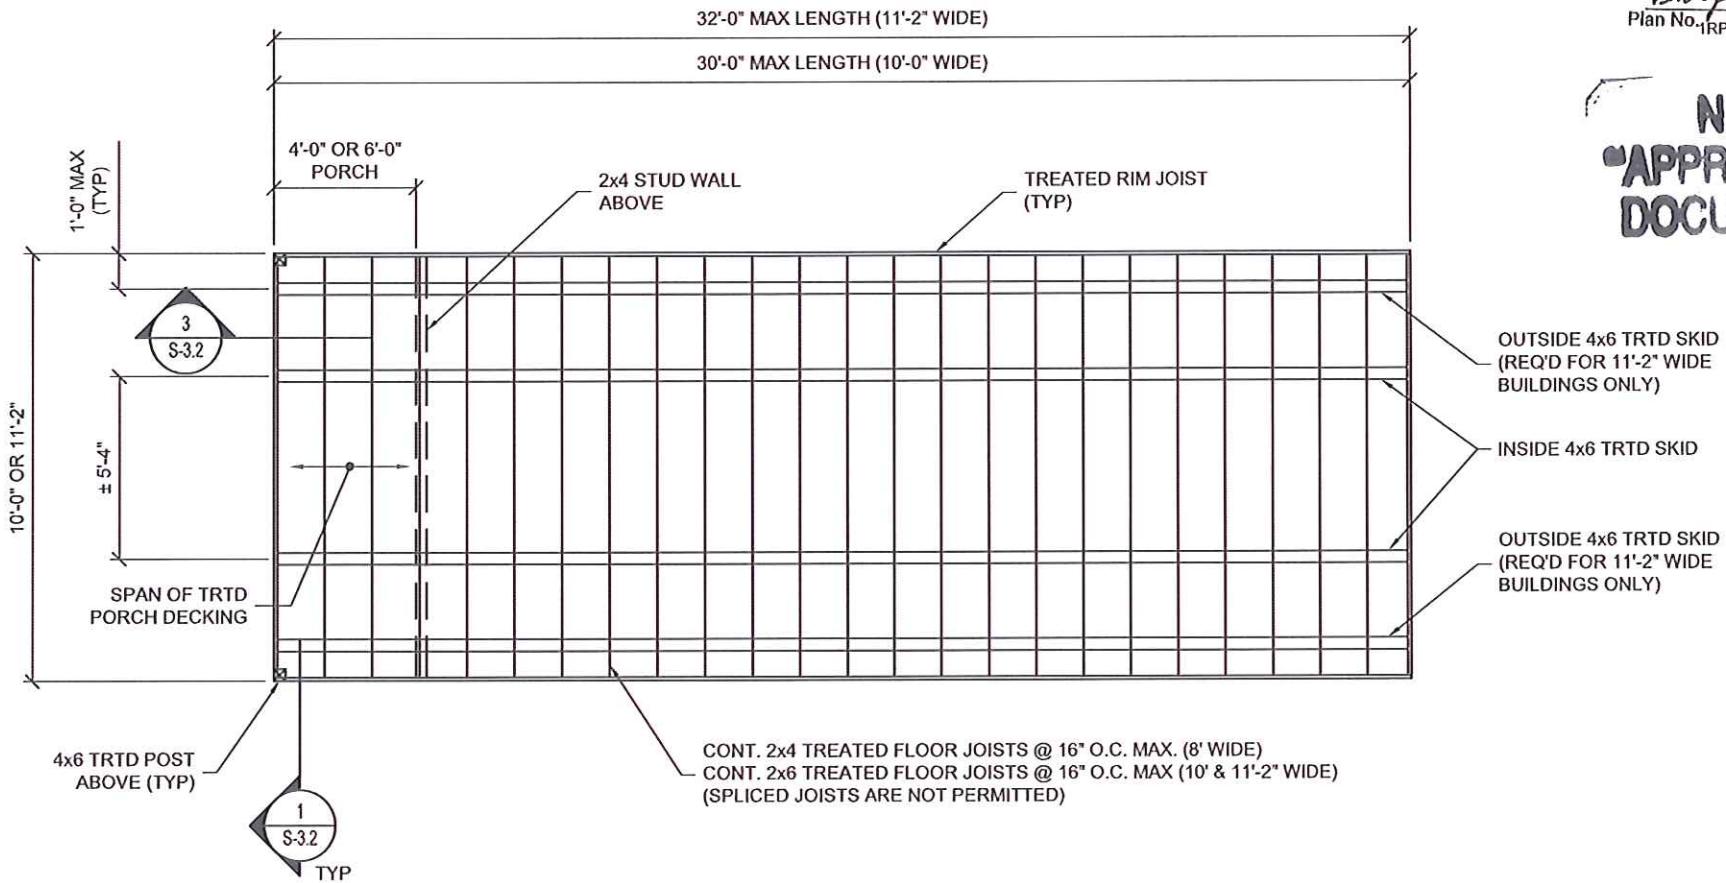
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REVISION:

SHEET NUMBER  
**S-10-LB**  
SCALE: NOT TO SCALE

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Florida PE-49070  
*Phillip E Robbins*  
Plan No. 1RPER210076 Date: 03/27/2023

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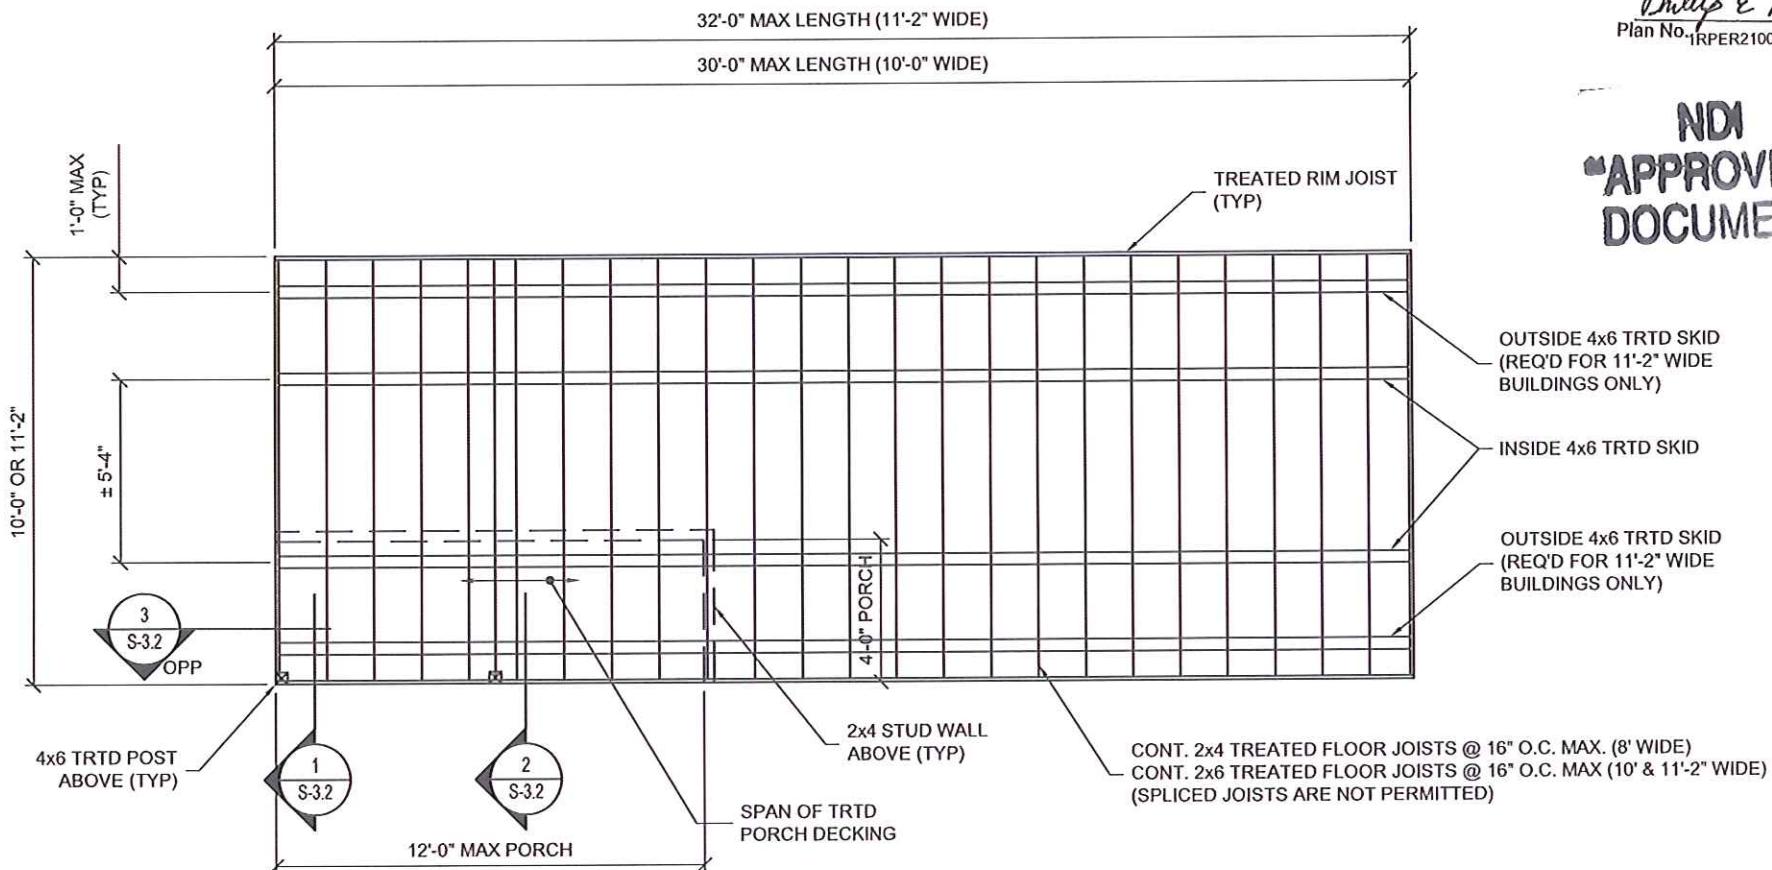
SHEET NUMBER

S-11-LB

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*Phillip E Robbins*  
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SIDE LOFTED BARN CABIN FLOOR FRAMING PLAN (OPTIONAL)



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Nolan, c=US  
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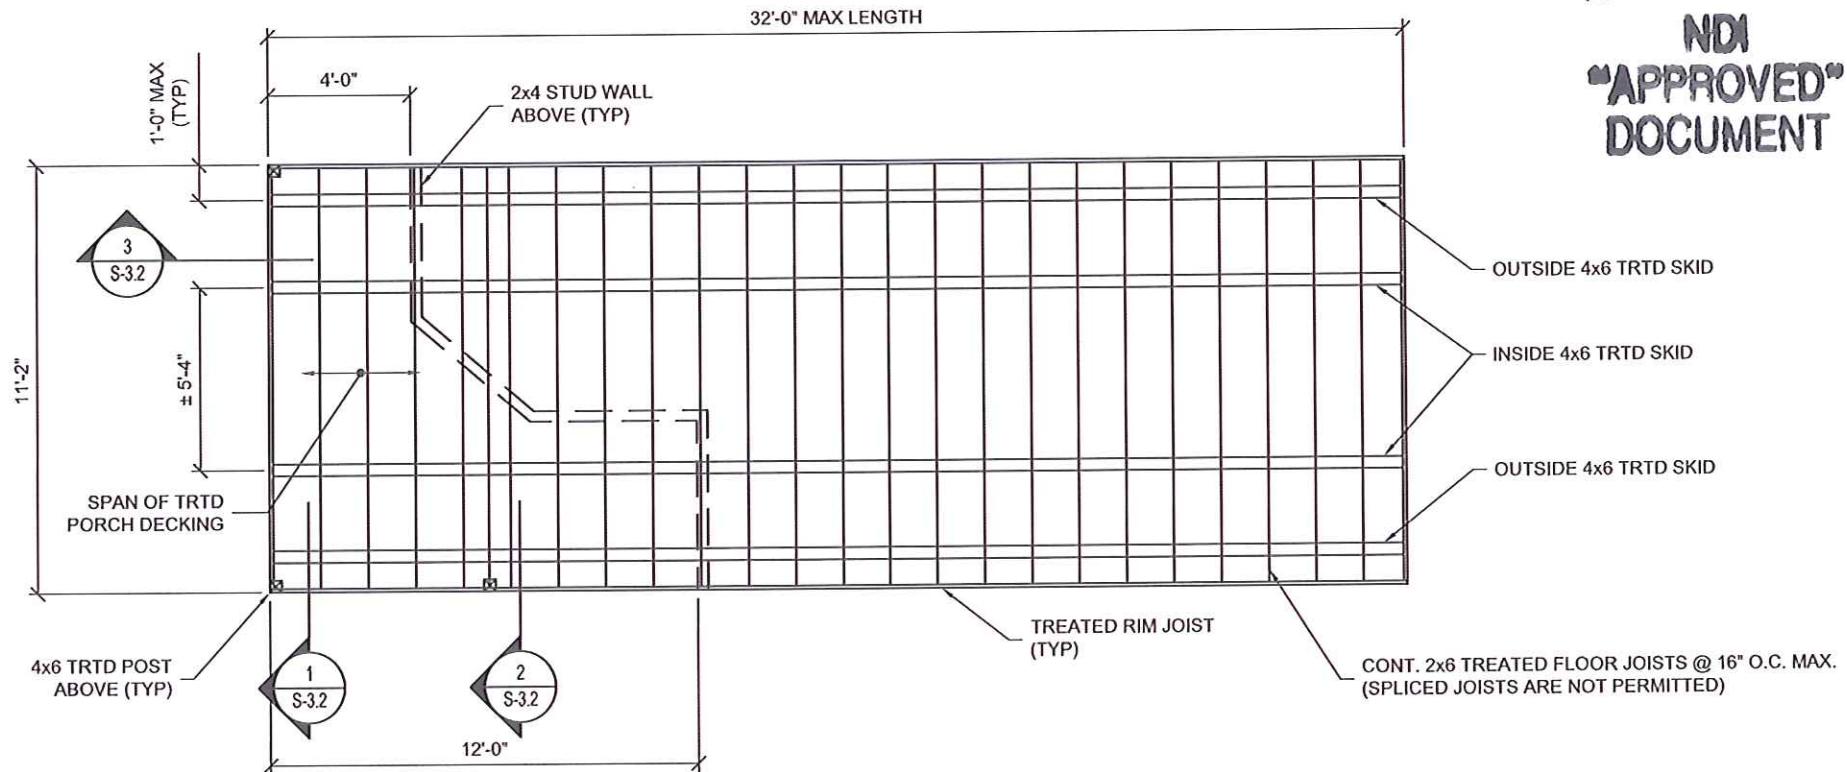
SHEET NUMBER

**S-12-LB**


SCALE: NOT TO SCALE

Approved by Phillip E Robbins  
Florida PE-49070  
Phillip E Robbins  
Plan No. 1RPER210076 Date: 03/27/2023

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DELUXE LOFTED BARN CABIN FLOOR FRAMING PLAN (OPTIONAL)



# LOFTED BARN--FLORIDA--WIND=160 MPH--FBC 2020
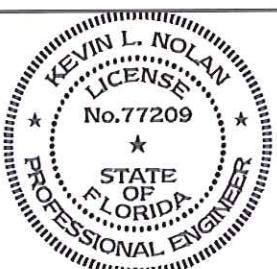
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c=US  
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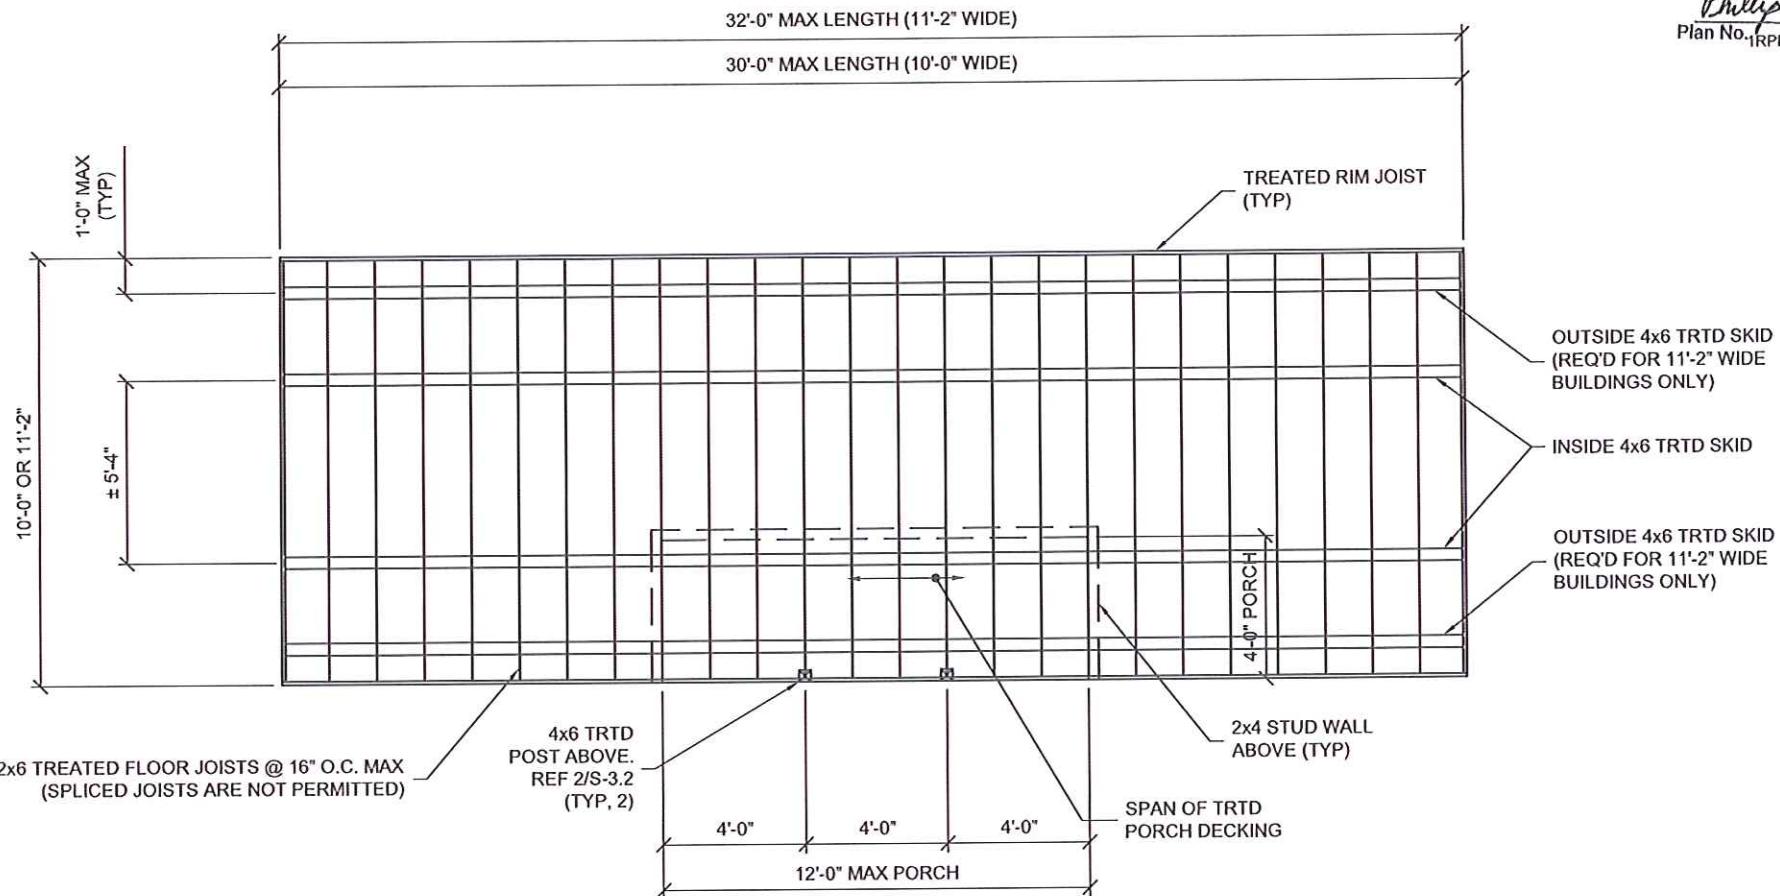
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**S-13-LB**

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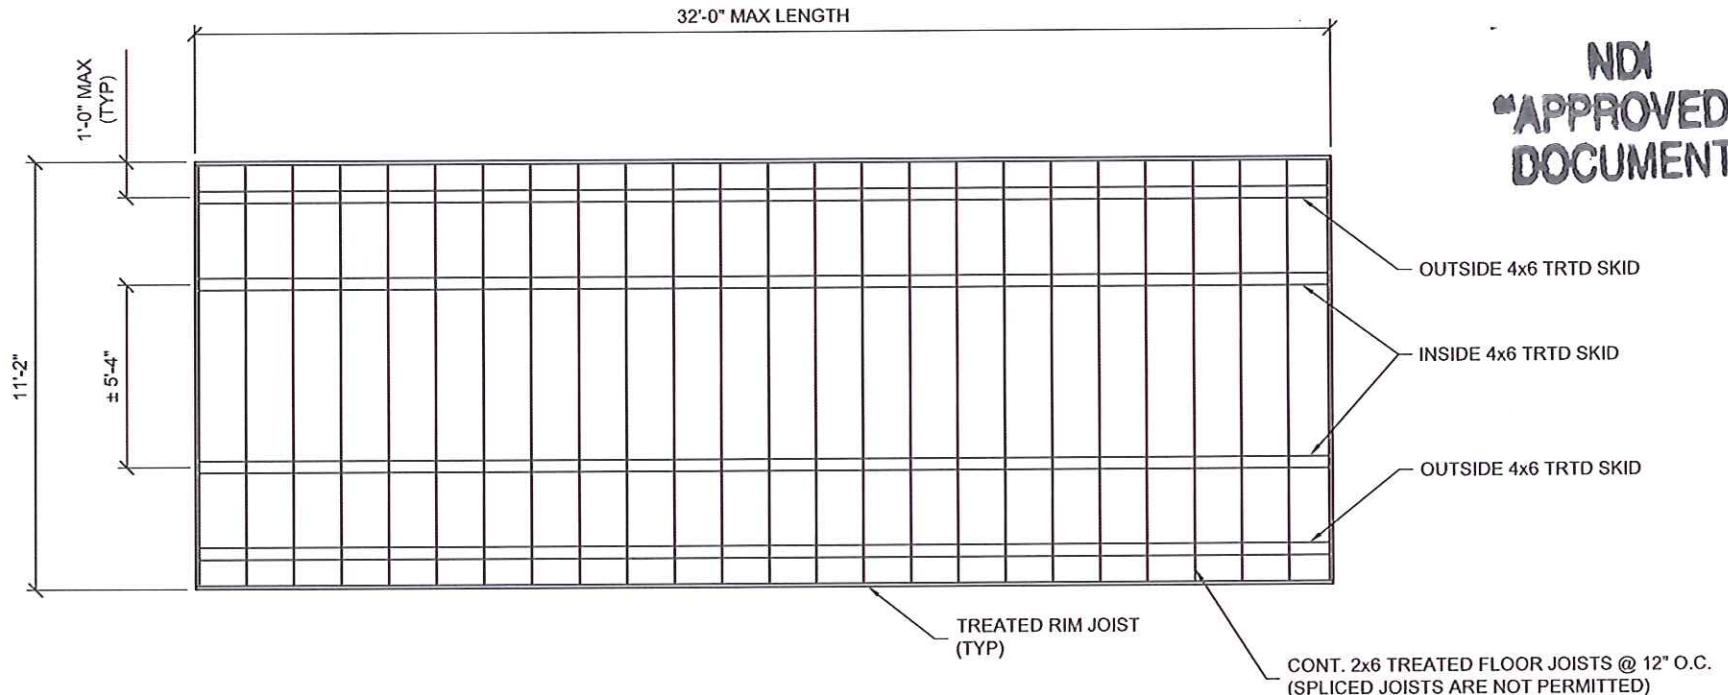
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**S-14-LB**  
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Florida PE-49070  
*Phillip E Robbins*  
Plan No. 1RPER210076 Date: 03/27/2023



LOFTED BARN w/ ROLL-UP DOOR FLOOR FRAMING PLAN (OPTIONAL)



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Date: 2023.03.22 13:48:25 -05'00'

*K. Nolan*

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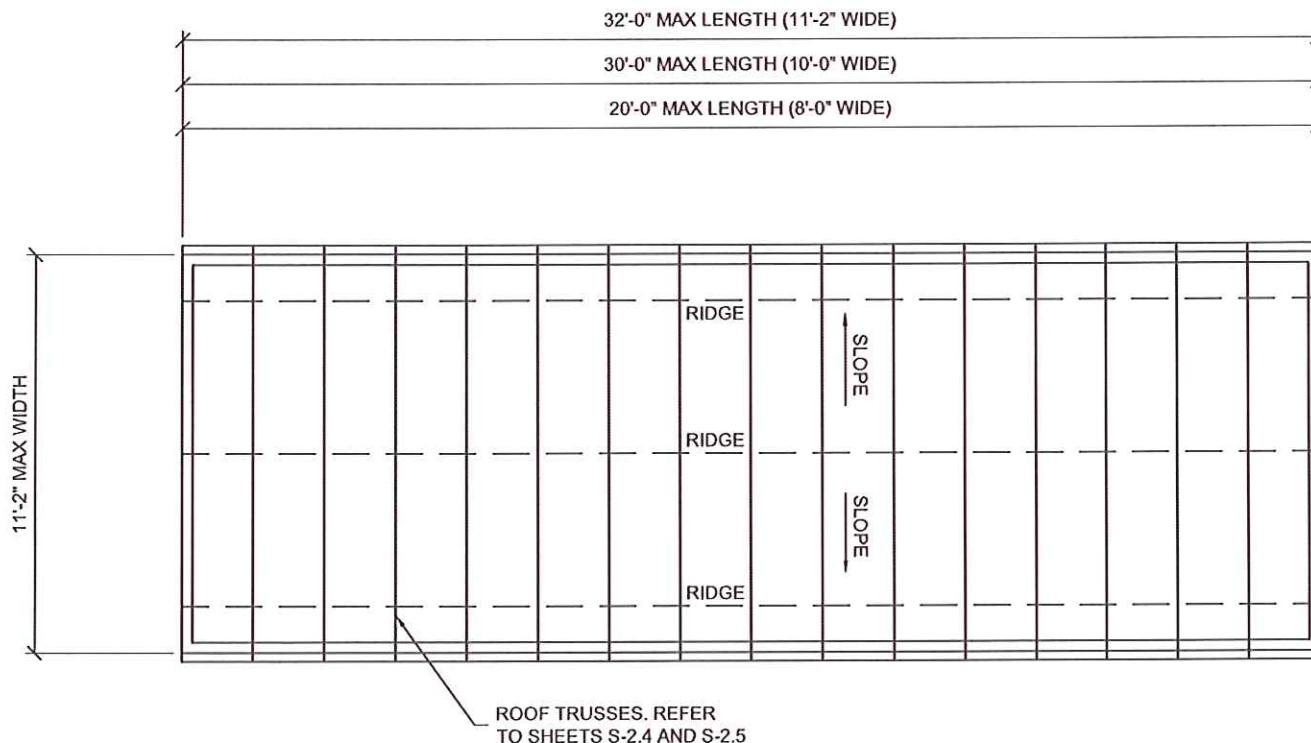
SHEET NUMBER

**S-15-LB**


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*Phillip E Robbins*  
Plan No. 1RPER210076 Date: 03/27/2023

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ROOF FRAMING PLAN



ROOF SHEATHING DIAGRAM

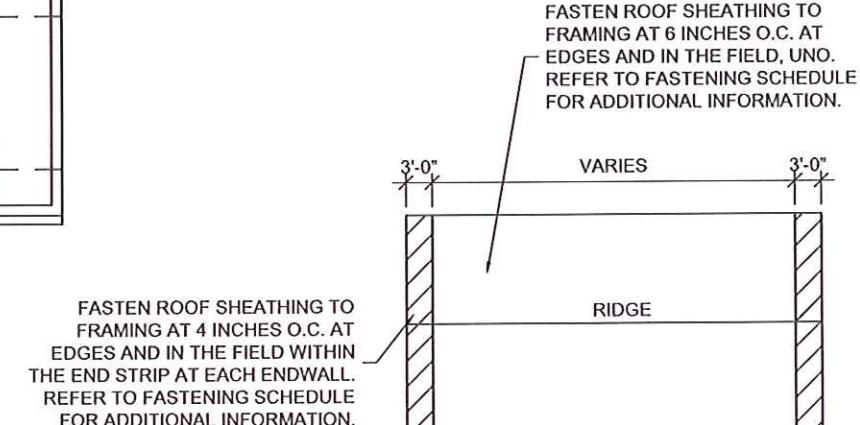

# LOFTED BARN--FLORIDA--WIND=160 MPH--FBC 2020


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cn=Kevin Nolan, c=US  
Date: 2023.03.22 13:49:25 -05'00'

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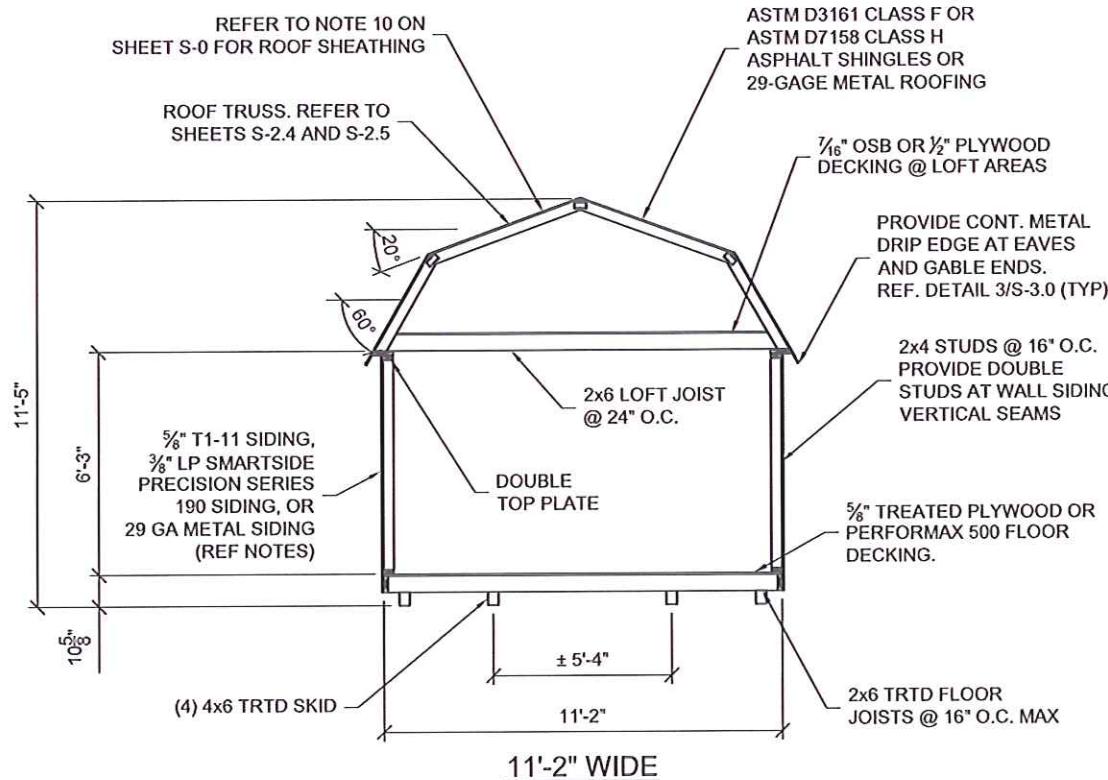
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REVISION: 03-22-2023

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**S-16-LB**  
SCALE: NOT TO SCALE



<p>KEVIN L. NOLAN LICENSE No. 77209 STATE OF FLORIDA PROFESSIONAL ENGINEER</p> <p><i>[Handwritten signature]</i></p> <p>Digitally signed by Kevin Nolan DN: 0.9.2342.19200300.100.1.1=A01410 C00000179D834EF80000196AF, cn=Kevin Nolan, c=US Date: 2023.03.22 13:49:58 -05'00'</p> <p>1. This item has been electronically signed and sealed by Kevin L Nolan, PE on 03/22/2023 using a digital signature. 2. Printed copies of this document are not considered signed and sealed and the signature must be verified on any electronic copy.</p>	<h1>LOFTED BARN--FLORIDA--WIND=160 MPH--FBC 2020</h1> <p><b>Weather King®</b> PORTABLE BUILDINGS</p>	
	<p>PROJECT NO: DATE: 09-28-2021 DRAWN BY: KLN CHECKED BY: KLN REVISION:</p>	<p>SHEET NUMBER <b>S-20-LB</b> SCALE: 1/4" = 1'-0"</p>

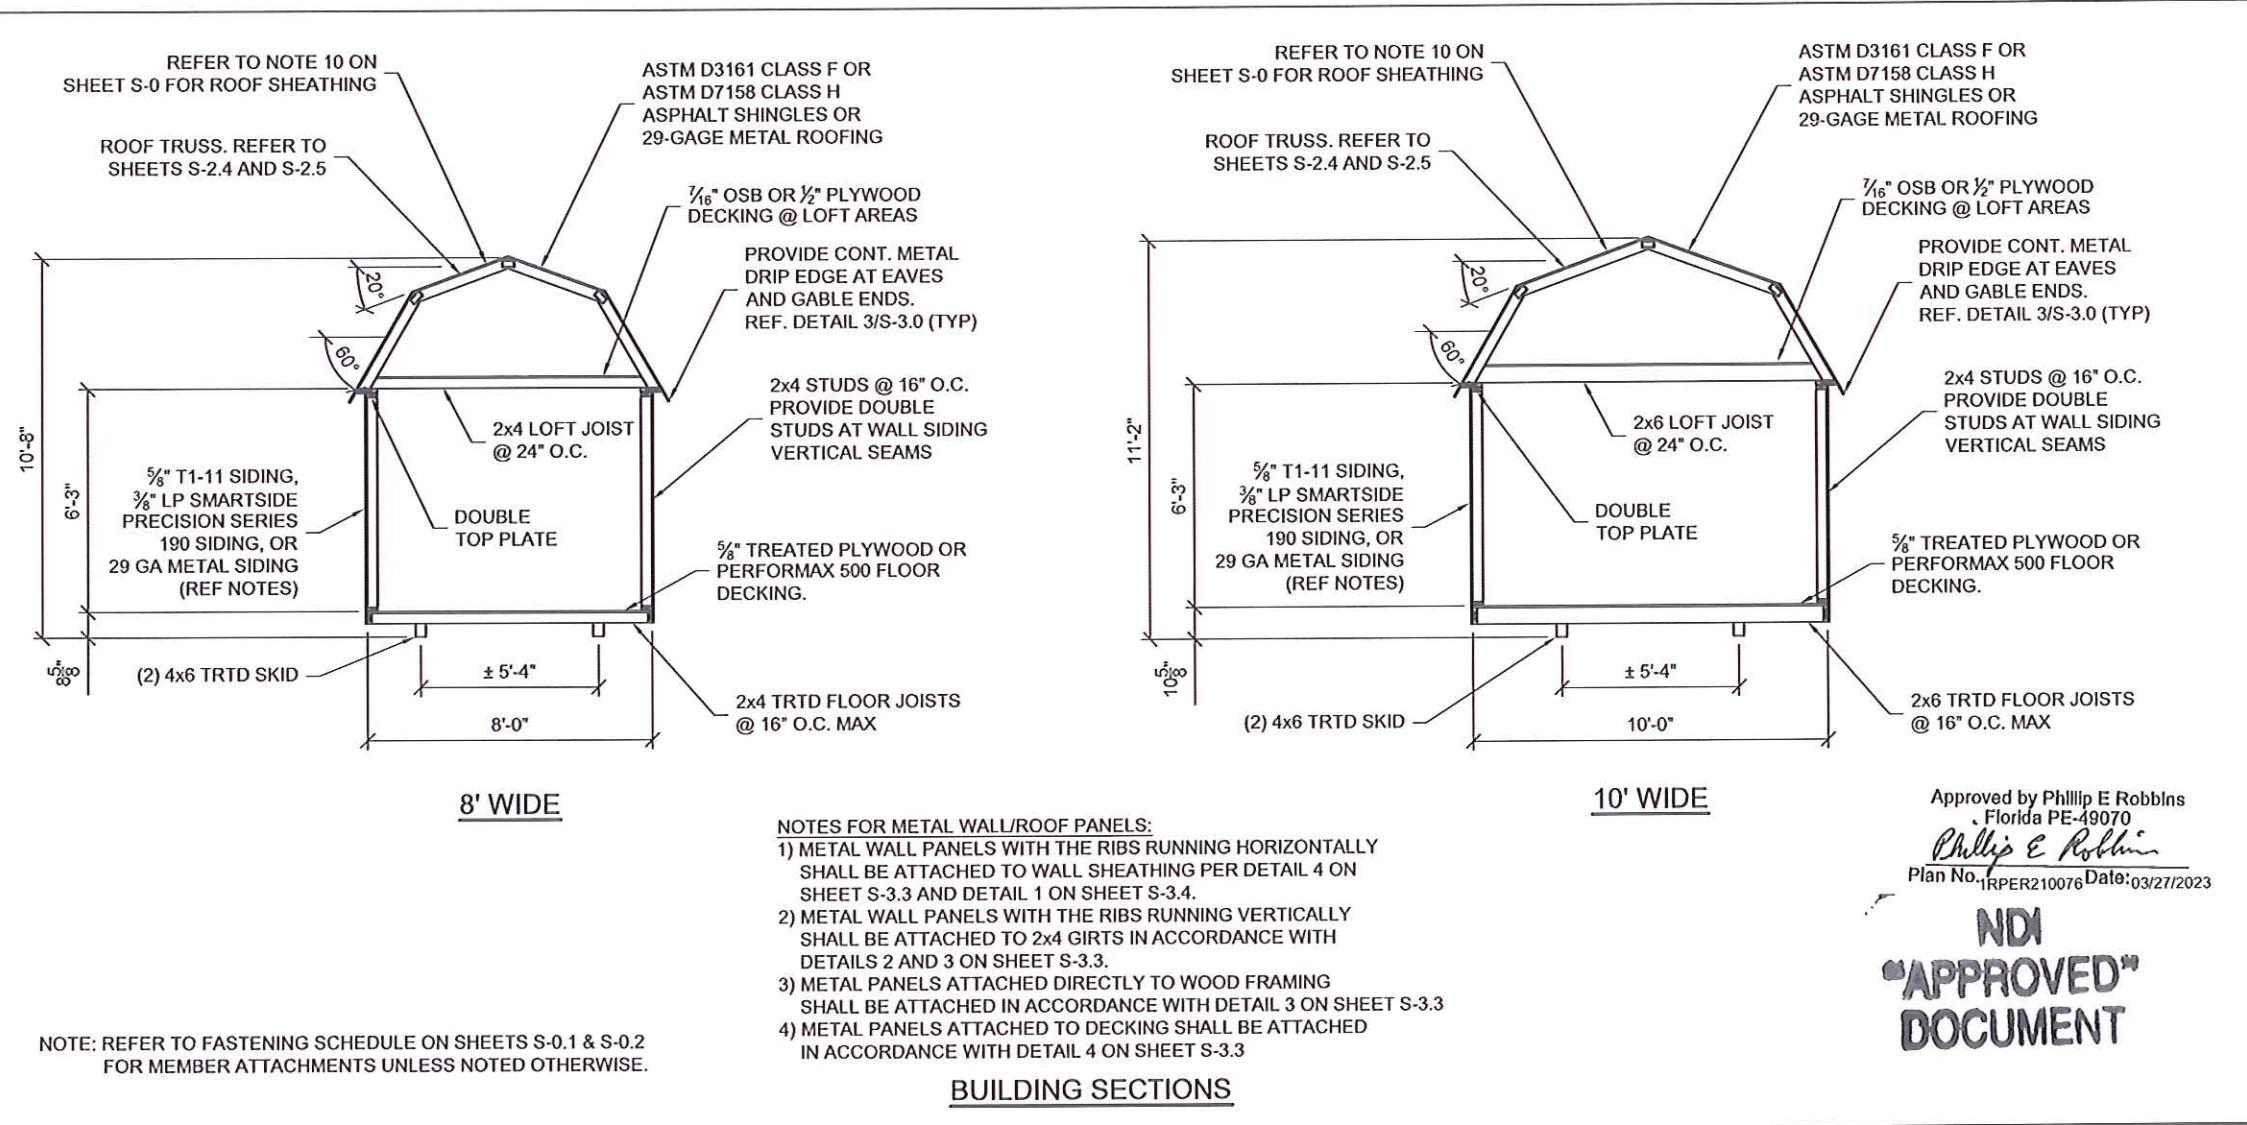

NOTES FOR METAL WALL/ROOF PANELS:

- 1) METAL WALL PANELS WITH THE RIBS RUNNING HORIZONTALLY SHALL BE ATTACHED TO WALL SHEATHING PER DETAIL 4 ON SHEET S-3.3 AND DETAIL 1 ON SHEET S-3.4.
- 2) METAL WALL PANELS WITH THE RIBS RUNNING VERTICALLY SHALL BE ATTACHED TO 2x4 GIRTS IN ACCORDANCE WITH DETAILS 2 AND 3 ON SHEET S-3.3.
- 3) METAL PANELS ATTACHED DIRECTLY TO WOOD FRAMING SHALL BE ATTACHED IN ACCORDANCE WITH DETAIL 3 ON SHEET S-3.3
- 4) METAL PANELS ATTACHED TO DECKING SHALL BE ATTACHED IN ACCORDANCE WITH DETAIL 4 ON SHEET S-3.3

Approved by Phillip E Robbins  
Florida PE-49070  
*Phillip E Robbins*  
Plan No. 1RPER210076 Date: 03/27/2023

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NOTE: REFER TO FASTENING SCHEDULE ON SHEETS S-0.1 & S-0.2  
FOR MEMBER ATTACHMENTS UNLESS NOTED OTHERWISE.

BUILDING SECTION



# LOFTED BARN--FLORIDA--WIND=160 MPH--FBC 2020

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cn=Kevin Nolan, c=US  
Date: 2023.03.22 13:50:28 -05'00'

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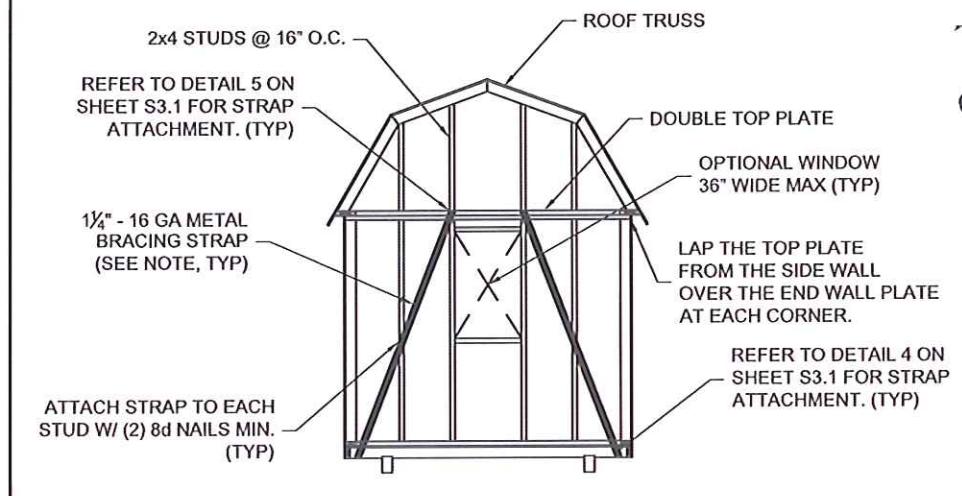
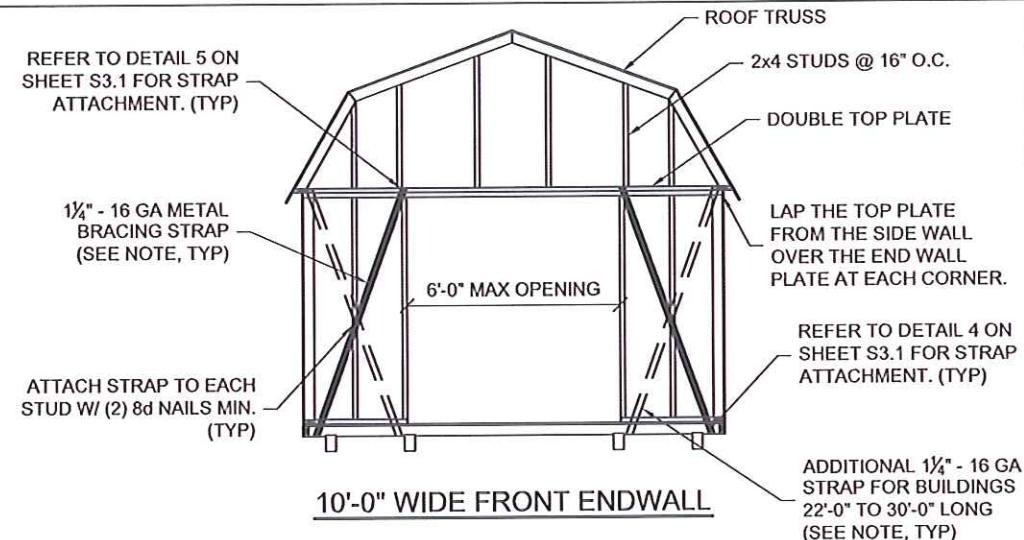
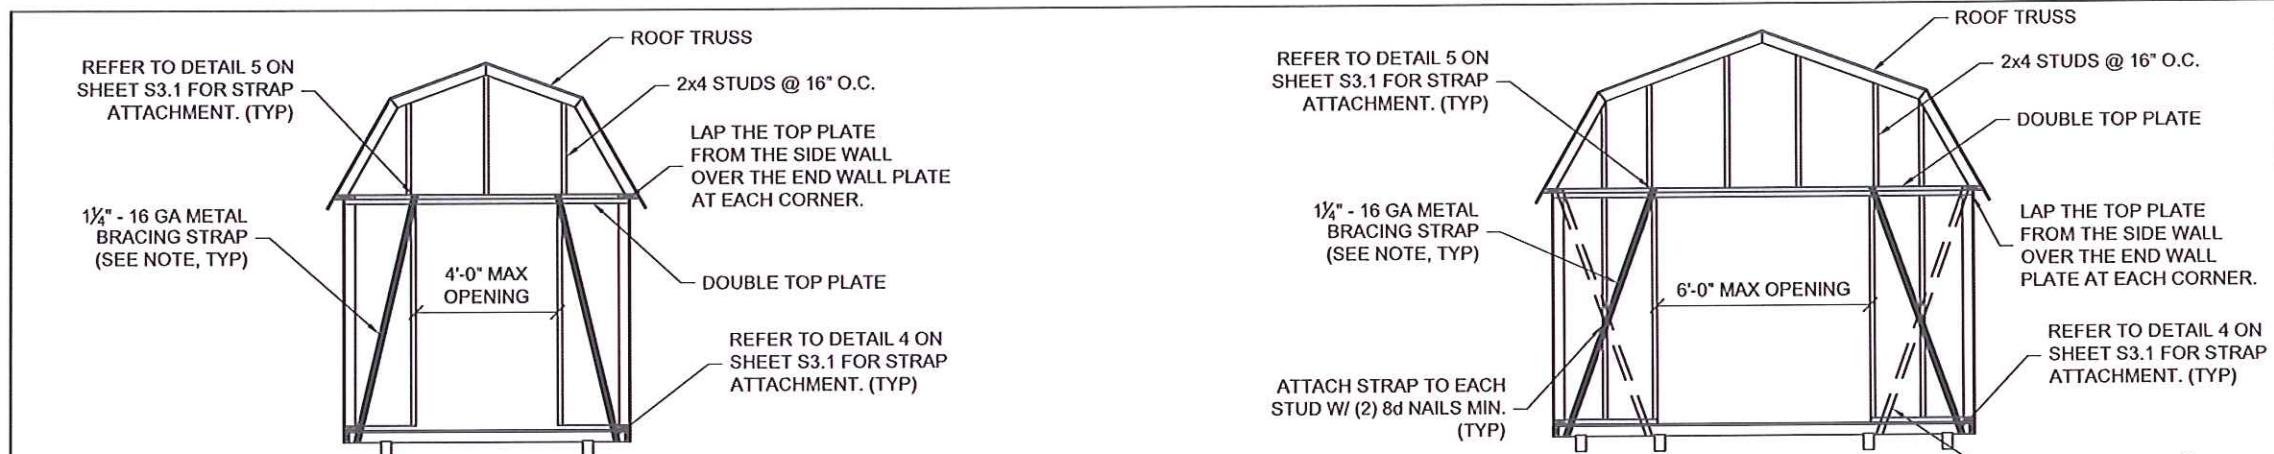
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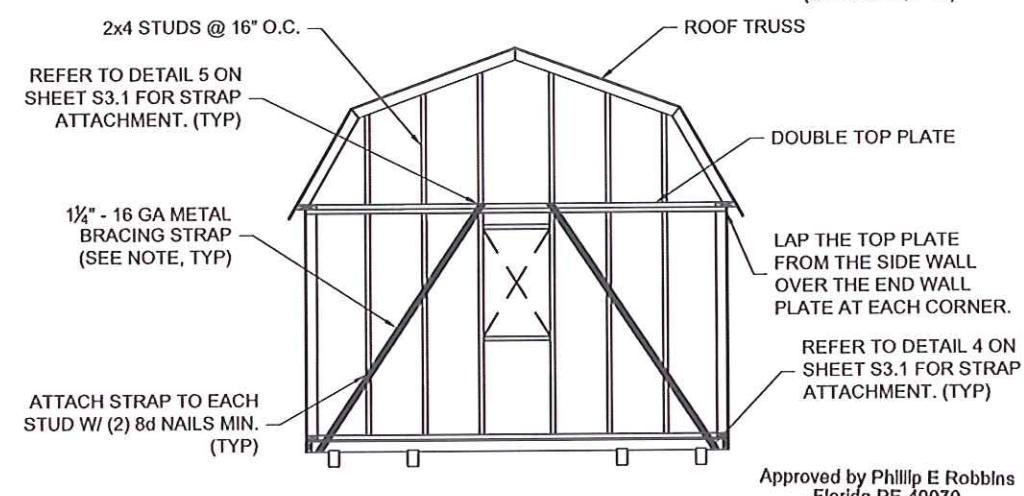
SHEET NUMBER

**S-21-LB**


SCALE: 1/4" = 1'-0"



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NOTE: METAL STRAP BRACING IS NOT REQUIRED FOR WALLS SHEATHED WITH WOOD SIDING, PLYWOOD, OR OSB



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c=US  
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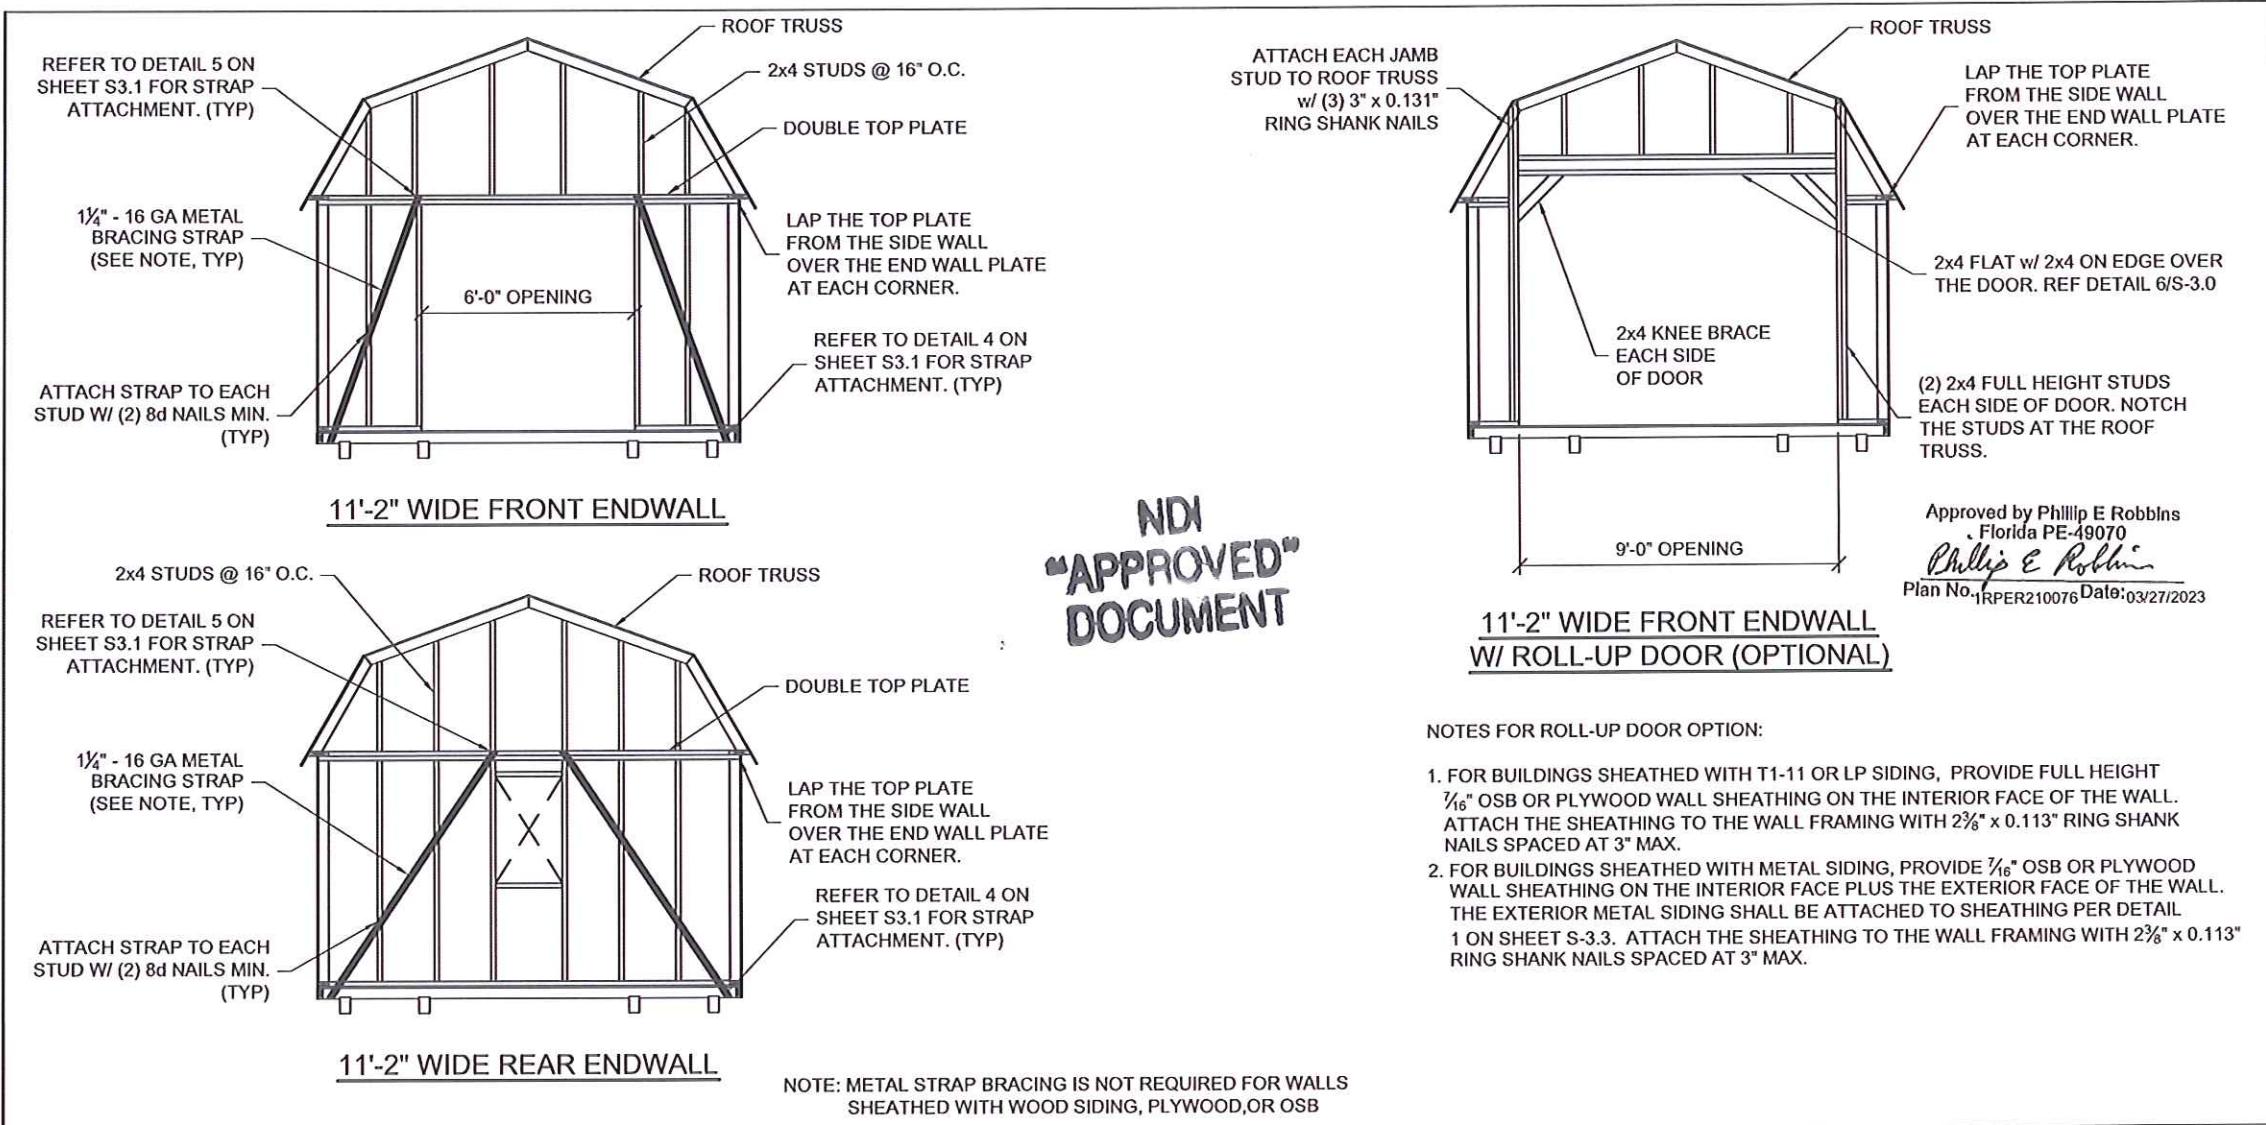
*Kevin Nolan*
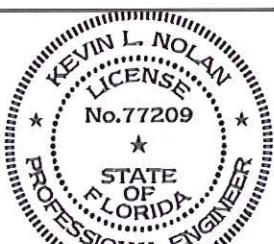
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DATE: 09-28-2021  
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REVISION:

SHEET NUMBER  
**S-22-LB**  
SCALE: NOT TO SCALE

Approved by Phillip E Robbins  
Florida PE-49070  
*Phillip E Robbins*  
Plan No: 1RPER210076 Date: 03/27/2023



# LOFTED BARN--FLORIDA--WIND=160 MPH--FBC 2020

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DN:  
0.9.2342.19200300.100.1.1=A01410C00  
000179D834EF80000196AF, cn=Kevin  
Nolan, c=US  
Date: 2023.03.22 13:52:40 -05'00'

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PORTABLE BUILDINGS

PROJECT NO:

DATE: 09-28-2021

DRAWN BY: KLN

CHECKED BY: KLN

REVISION:


SHEET NUMBER

**S-23-LB**

SCALE: NOT TO SCALE

GENERAL NOTES:


1. REFER TO SHEET S-0 FOR DESIGN LOADS.
2. MAXIMUM TRUSS SPACING = 24" O.C. UNLESS NOTED OTHERWISE.
3. TRUSS TOP CHORD SHALL BE BRACED W/ STRUCTURAL WOOD SHEATHING ATTACHED DIRECTLY TO TRUSS MEMBERS.
4. ALL TRUSS MEMBERS ARE TO BE SPF #2 OR BETTER.
5. TRUSS PLATES ARE TO BE A MINIMUM OF 20 GAGE (MT20) HYDRAULICALLY PRESSED IN PLACE EACH SIDE OF TRUSS.
6. REACTIONS DUE TO WIND ARE BASED ON MWFRS END ZONE PRESSURES. INDIVIDUAL MEMBERS DESIGNED FOR COMPONENTS AND CLADDING WIND PRESSURE.
7. DEFLECTION MEETS L/240 LIVE LOAD AND L/180 TOTAL LOAD.
8. LOAD DURATION ADJUSTMENT FACTORS:  
ROOF LIVE: 1.25  
WIND: 1.60
9. REPETITIVE MEMBER INCREASE: 1.15
10. HORIZONTAL THRUST IS TO BE RESISTED BY LOFT JOISTS. REFER TO SHEETS S-2.0, S-2.1, AND S-3.0 FOR LOFT JOIST SIZE, AND ATTACHMENT INFORMATION.

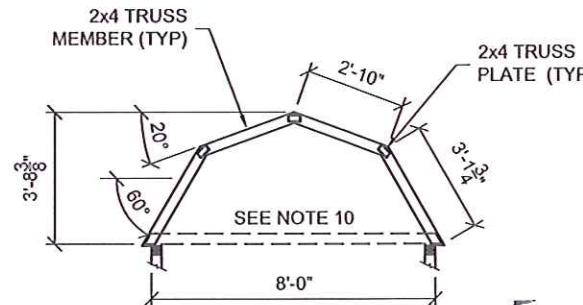

8' WIDE LOFTED BARN TRUSS

MAX REACTIONS  
HORIZ: 108 LBS.  
NET UPLIFT: -175 LBS.  
GRAVITY: 269 LBS.


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10' WIDE LOFTED BARN TRUSS

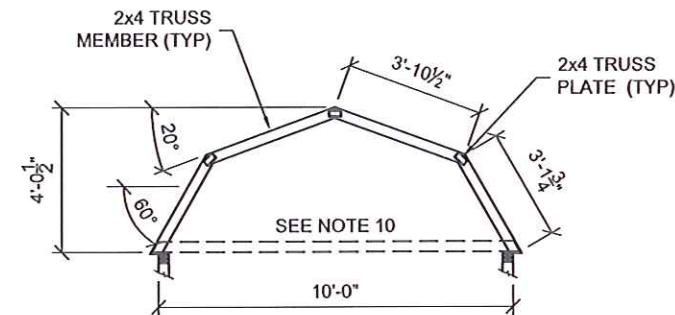
MAX REACTIONS  
HORIZ: 121 LBS.  
NET UPLIFT: -227 LBS.  
GRAVITY: 333 LBS.

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Plan No. 1RPER210076 Date: 03/27/2023




8' WIDE LOFTED BARN TRUSS (OPTIONAL)

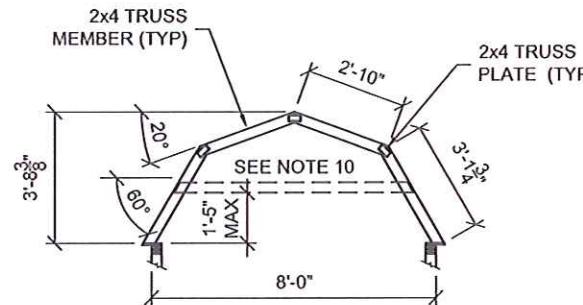MAX REACTIONS  
HORIZ: 108 LBS.  
NET UPLIFT: -179 LBS.  
GRAVITY: 250 LBS.

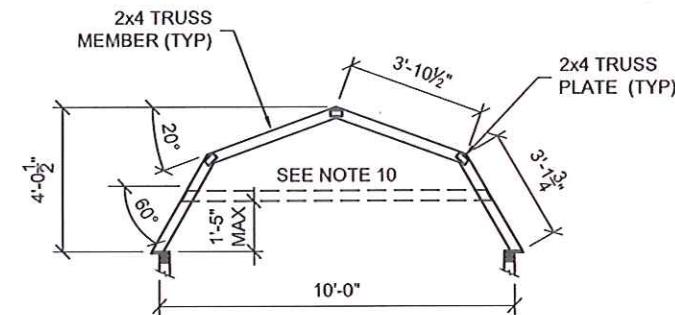

10' WIDE LOFTED BARN TRUSS (OPTIONAL)

MAX REACTIONS  
HORIZ: 121 LBS.  
NET UPLIFT: -231 LBS.  
GRAVITY: 314 LBS.

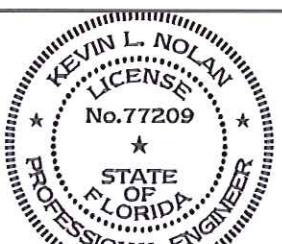

# LOFTED BARN--FLORIDA--WIND=160 MPH--FBC 2020

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DN: 0.9.2342.19200300.100.1.1=A01410C000  
00179D834EF80000196AF, cn=Kevin  
Nolan, c=US  
Date: 2023.03.22 13:53:18-05'00'

*Kevin Nolan*

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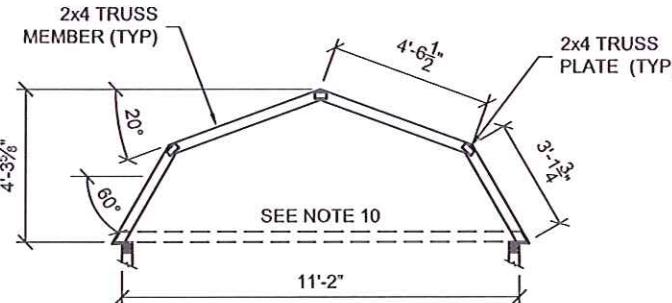
CHECKED BY: KLN

REVISION:

SHEET NUMBER


**S-24-LB**

SCALE: 1/4" = 1'-0"



MAX REACTIONS  
HORIZ: 125 LBS.  
NET UPLIFT: -258 LBS.  
GRAVITY: 370 LBS.

### 11'-2" WIDE LOFTED BARN TRUSS

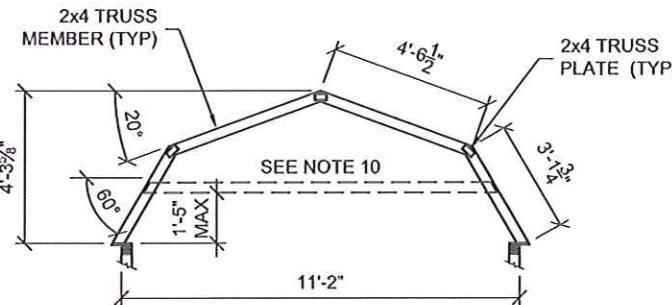

MAX REACTIONS  
HORIZ: 125 LBS.  
NET UPLIFT: -262 LBS.  
GRAVITY: 351 LBS.

### 11'-2" WIDE LOFTED BARN TRUSS (OPTIONAL)

Approved by Phillip E Robbins  
Florida PE-49070  
*Phillip E Robbins*  
Plan No. IRPER210076 Date: 03/27/2023

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# LOFTED BARN--FLORIDA--WIND=160 MPH--FBC 2020

Digitally signed by Kevin Nolan  
DN: 0.9.2342.19200300.100.1.1=A01410C  
00000179D834EF80000196AF,  
cn=Kevin Nolan, c=US  
Date: 2023.03.22 13:53:54 -05'00'

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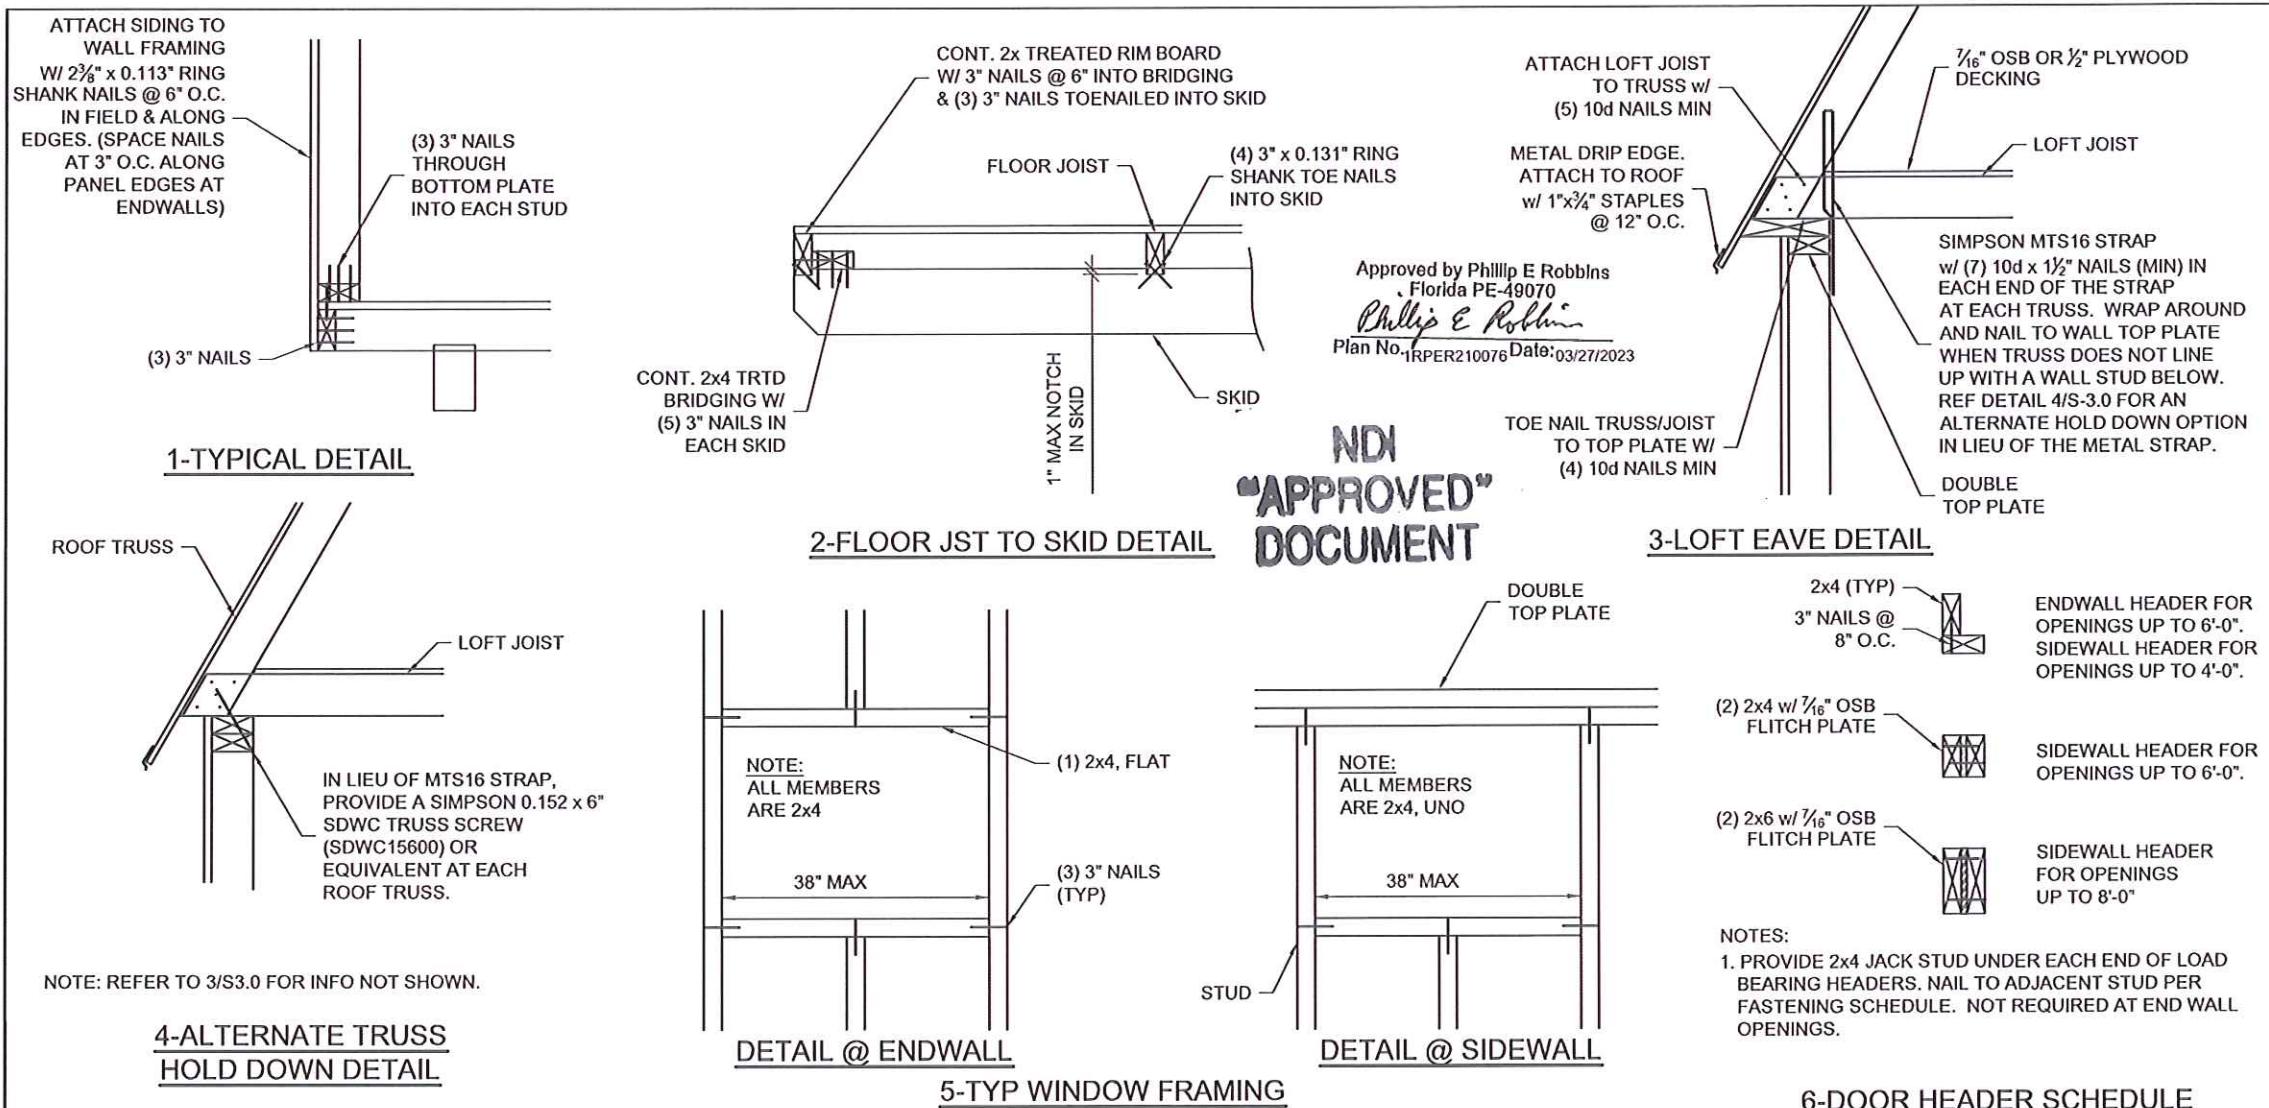
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REVISION:

SHEET NUMBER

**S-25-LB**

SCALE: 1/4" = 1'-0"



# LOFTED BARN--FLORIDA--WIND=160 MPH--FBC 2020

NOTE: REFER TO FASTENING SCHEDULE ON SHEETS S-0.1 AND S-0.2 FOR ATTACHMENT INFORMATION NOT NOTED ON THIS SHEET.

Digitally signed by Kevin Nolan  
DN: 0.9.2342.1920030.100.1.1=A01410C0000017  
90334EF80000196AF, cn=Kevin Nolan, c=US  
Date: 2023.03.22 13:54:36 -05'00'

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CHECKED BY: KLN  
REVISION:

SHEET NUMBER  
**S-30-LB**  
SCALE: 1"=1'-0"

**1- ROOF TRUSS (TYP)**

ROOF TRUSS (TYP), TOP PLATE JOINT, CONT. DOUBLE TOP PLATE, BOTTOM PLATE JOINT OVER A STUD, STUD (TYP), 24" MIN

**2- SKID SPlice DETAIL**

VARIES (SEE PLAN), TREATED 2x4 x 6'-0" LONG SPLICE PLATE CENTERED ON SPLICE, EACH SIDE OF SKID w/ 2 ROWS 10d NAILS @ 4" O.C. STAGGERED, Approved by Phillip E Robbins, Florida PE-49070, Phillip E Robbins, Plan No. IRPER210076 Date: 03/27/2023, TREATED 4x6 SKID

**1- WALL TOP PLATE SPLICE DETAIL**

SIMPSON MTS16 STRAP w/ (7) 10d x 1½" NAILS (MIN) IN EACH END OF THE STRAP AT EACH TRUSS. WRAP AROUND TOP PLATE. REF DETAIL 4/S-3.0 FOR AN ALTERNATE HOLD DOWN OPTION IN LIEU OF THE METAL STRAP. PORCH POST BEYOND. REF DETAILS ON SHEET S3.2 FOR ADD'L INFO. 7/16" OSB OR ½" PLYWOOD DECKING, LOFT JOIST, 5/8" P.T. PLYWOOD CEILING AT PORCH ONLY. DOUBLE TOP PLATE EXTENDED FROM BUILDING

**4-STRAP ATTACHMENT**

1¼" - 16 GA STEEL STRAP. WRAP AROUND JOIST & ATTACH TO JOIST W/ (4) 10d X 1½" NAILS EACH SIDE OF JOIST.

**5-STRAP ATTACHMENT**

1¼" - 16 GA STEEL STRAP. WRAP OVER WALL TOP PLATE. PROVIDE (3) 8d NAILS INTO TOP OF PLATE. PROVIDE (5) 10d NAILS MIN INTO STUD / SIDE OF PLATE.

**6-TYPICAL CORNER DETAIL**

DOUBLE TOP PLATE, STUD, 3" NAILS @ 12" O.C., (2) 2x4 STUDS (SIDE WALL), 2x4 STUD (END WALL), 3" NAILS @ 12" O.C. STAGGERED

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**LOFTED BARN--FLORIDA--WIND=160 MPH--FBC 2020**

**NOTE: REFER TO 3/S3.0 FOR INFO NOT SHOWN.**

**3- PORCH EAVE DETAIL**

**SCALE = 1½" = 1'-0"**

**PROJECT NO:**

**DATE:** 09-28-2021

**DRAWN BY:** KLN

**CHECKED BY:** KLN

**REVISION:**

**SHEET NUMBER:**

**S-3.1-LB**

**SCALE: 1"=1'-0"**



**NOTE: REFER TO FASTENING SCHEDULE ON SHEETS S-0.1 AND S-0.2 FOR ATTACHMENT INFORMATION NOT NOTED ON THIS SHEET.**

Digitally signed by Kevin Nolan  
DN: 0.9.2342.19200300.100.1.1-A01410C0000017  
9D834EF80000196AF, cn=Kevin Nolan, c=US  
Date: 2023.03.22 13:55:27 -05'00'

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DS34EF80000195AF, Cn=Kevin Nolan, c=US  
Date: 2023.03.22 13:56:13-05'00'

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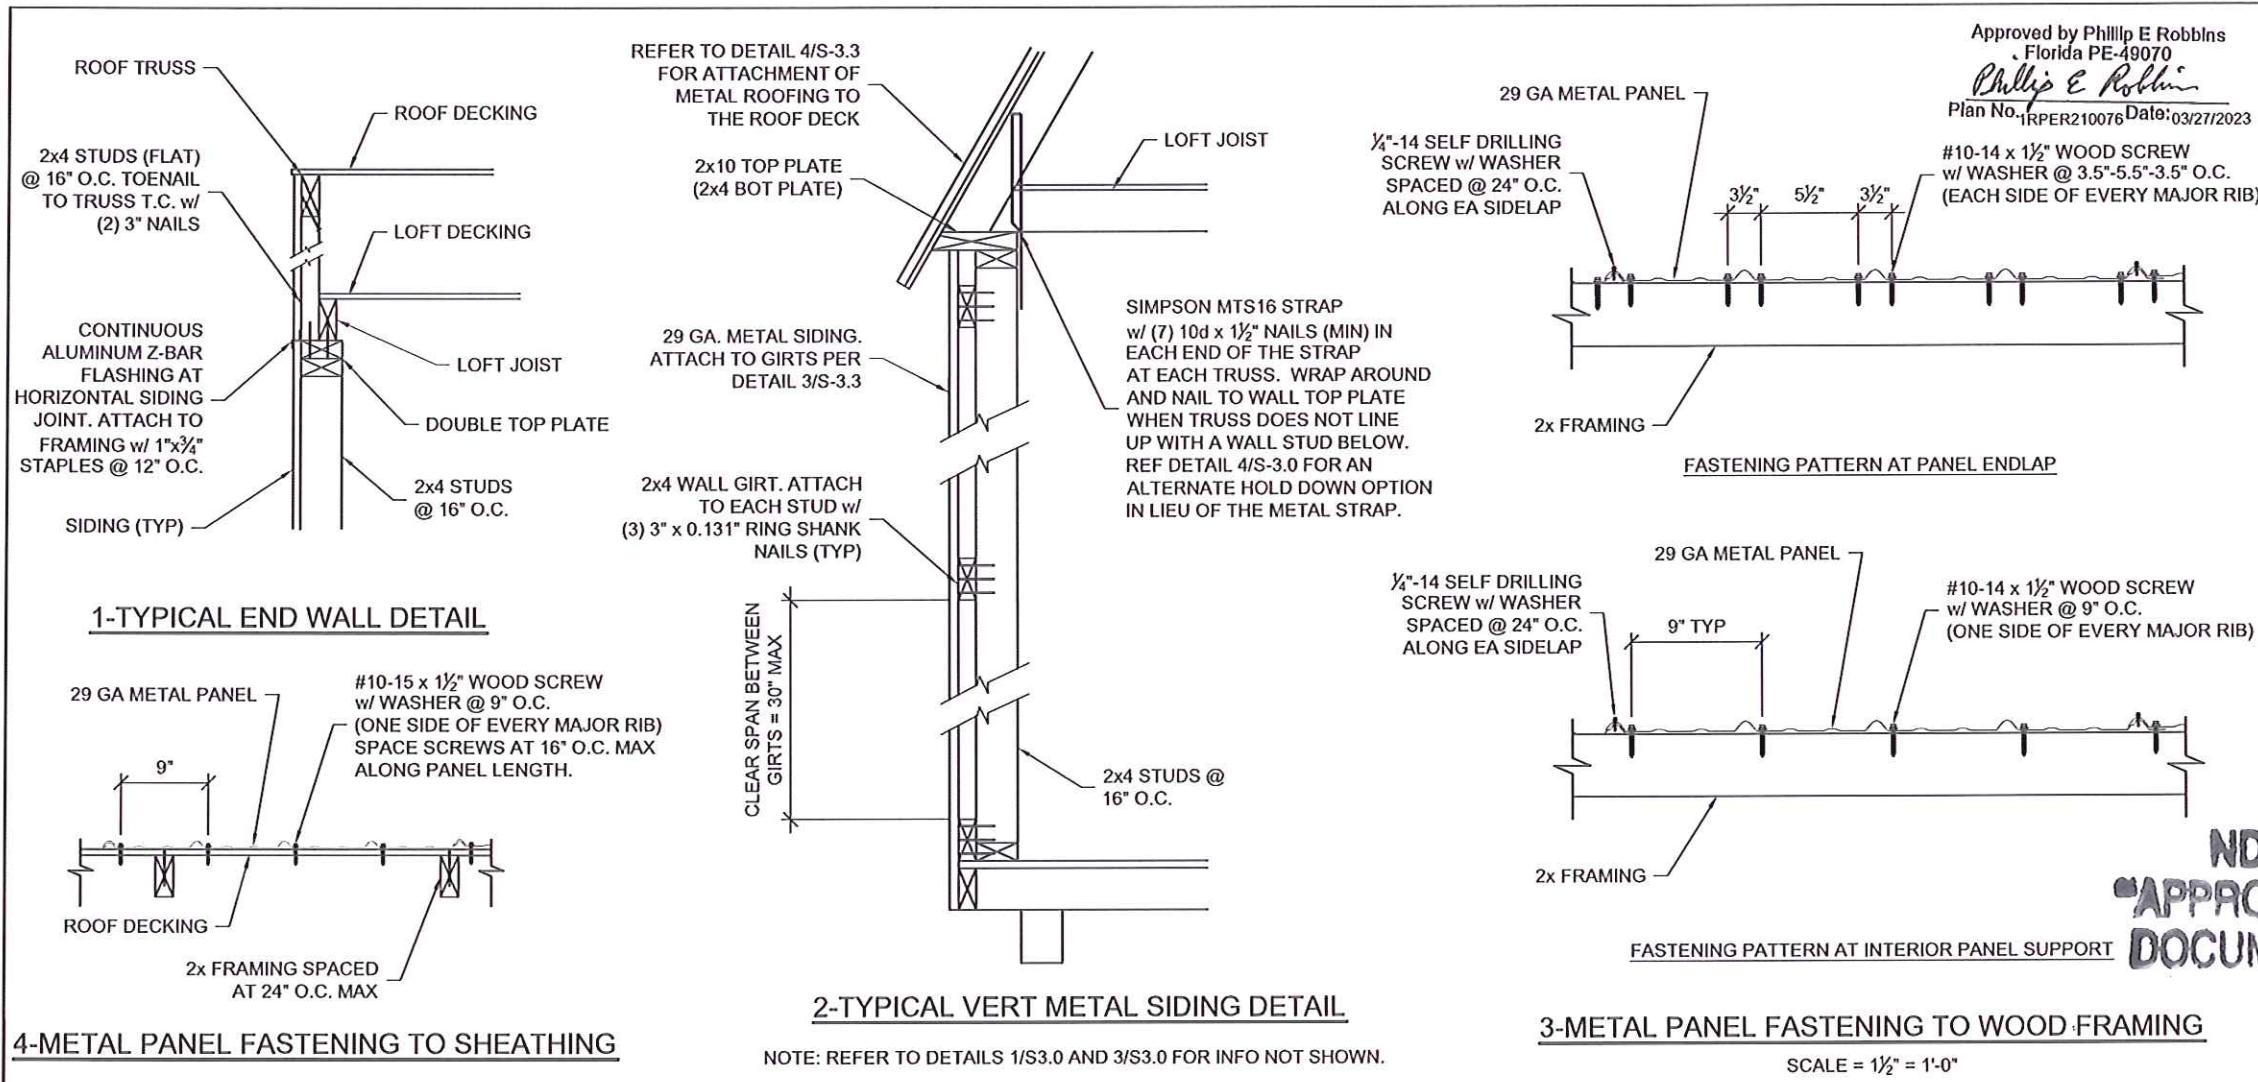
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SHEET NUMBER

**S-3.2-LB**

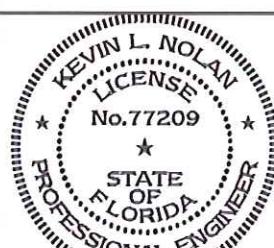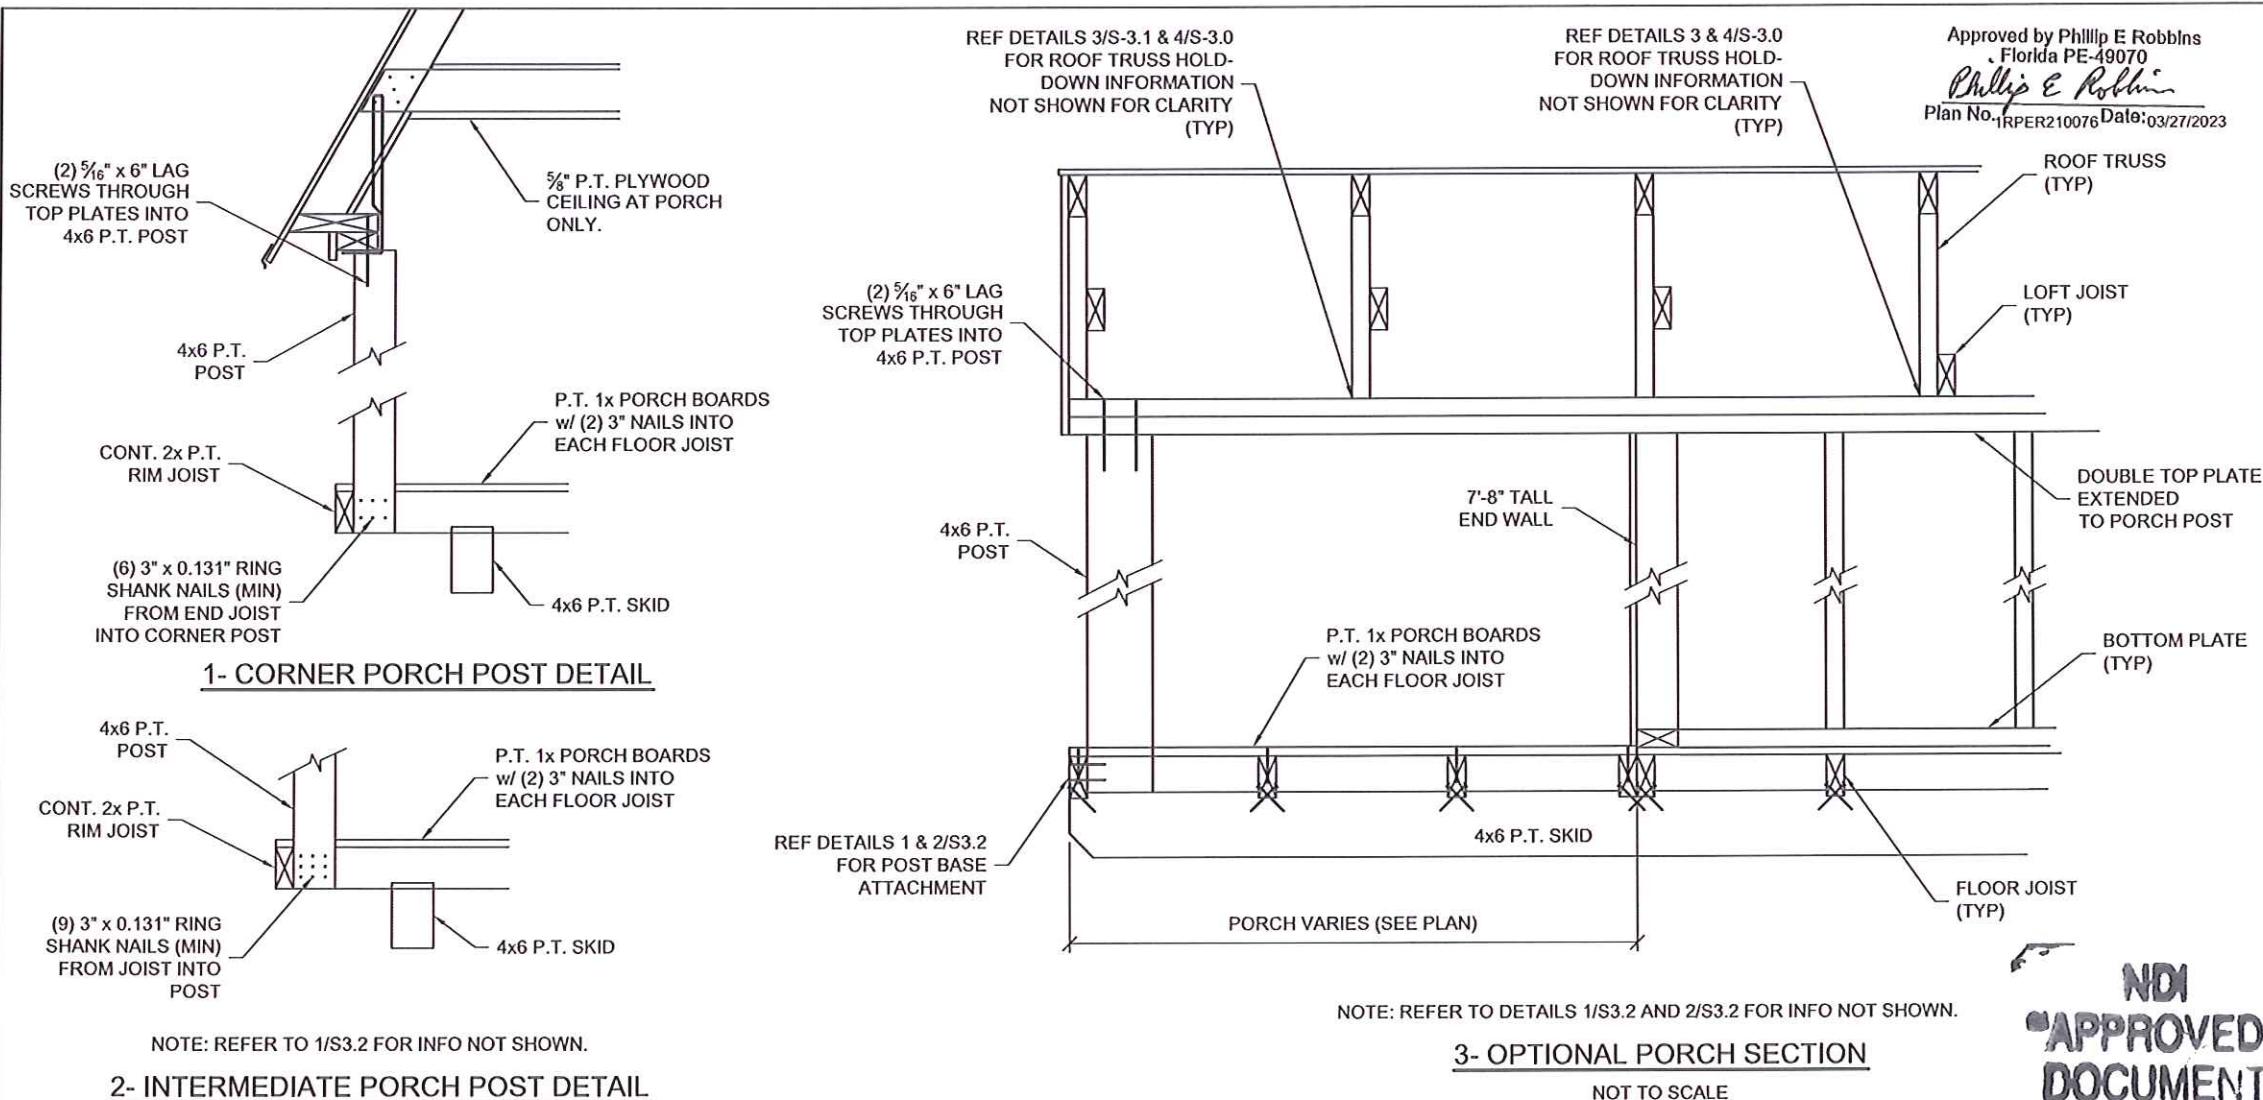SCALE: 1"=1'-0



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*knolan*

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DN: 09.2342.19200300.100.1=A0141000000179  
DS34EF00000196AF, cn=Kevin Nolan, c=US  
Date: 2023.03.22 13:57:05 -05'00'

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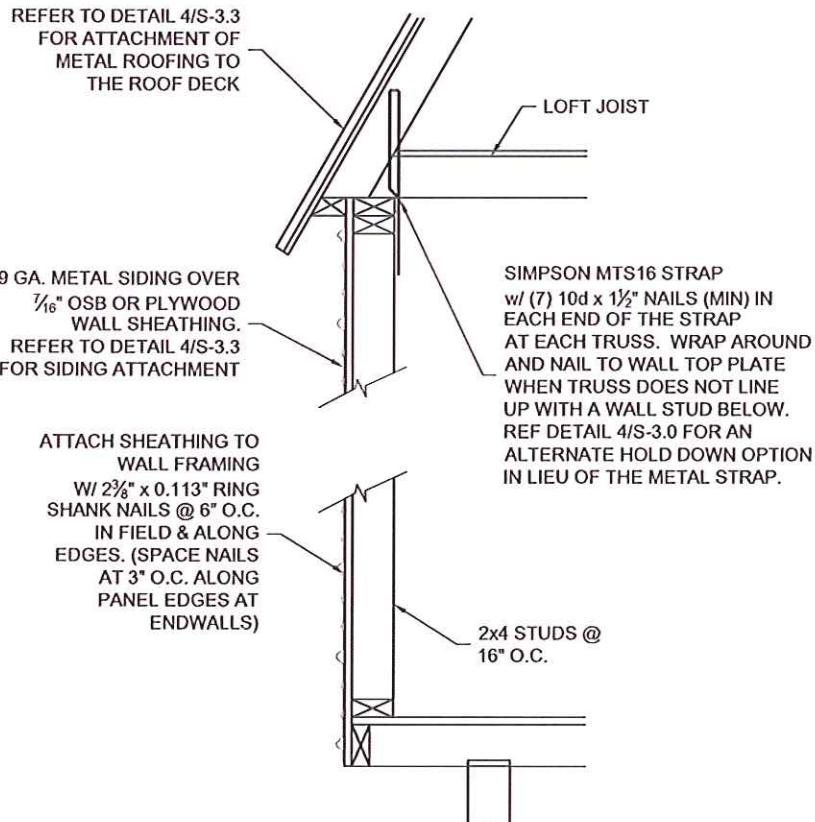
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SHEET NUMBER

**S-3.3-LB**

SCALE: 1"=1'-0"



1-TYPICAL HORIZ METAL SIDING DETAIL

NOTE: REFER TO DETAILS 1/S3.0 AND 3/S3.0 FOR INFO NOT SHOWN.

Approved by Phillip E Robbins  
Florida PE-49070  
*Phillip E Robbins*  
Plan No. 1RPER210076 Date: 03/27/2023

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DN: 0.9.2342.19200300.100.1.1-A01410C00009179  
D034F20000196AF, cn=Kevin Nolan, c=US  
Date: 2023.03.22 13:58:01 -05'00'

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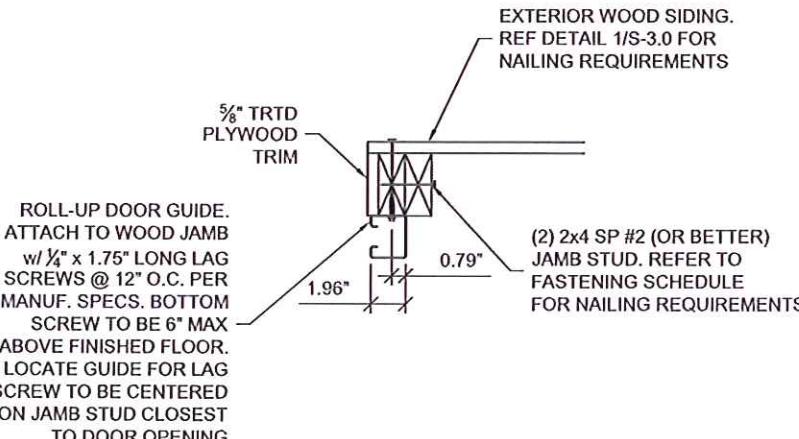
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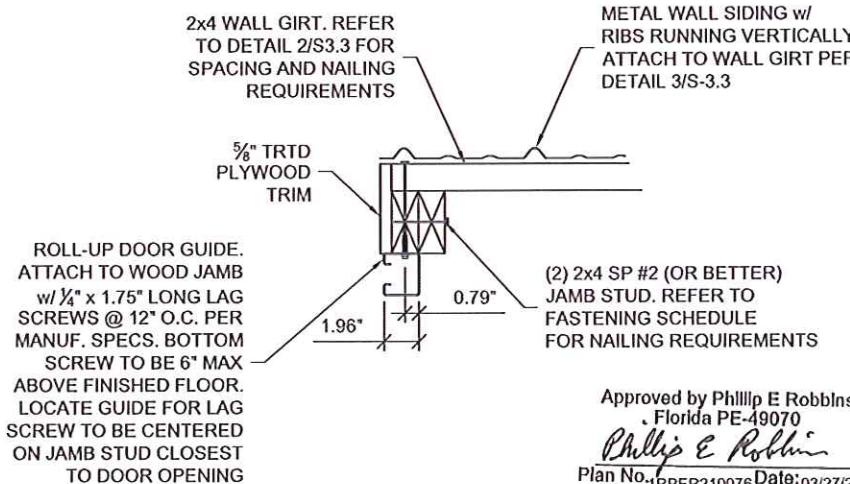
SHEET NUMBER

**S-34-LB**

SCALE: 1"=1'-0"




1-ROLL-UP DOOR JAMB DETAIL  
(WOOD SIDING)



Approved by Phillip E Robbins  
Florida PE-49070  
*Phillip E. Robbins*  
Plan No: 1RPER210076 Date: 03/27/2023

3-ROLL-UP DOOR JAMB DETAIL  
(VERT METAL SIDING)

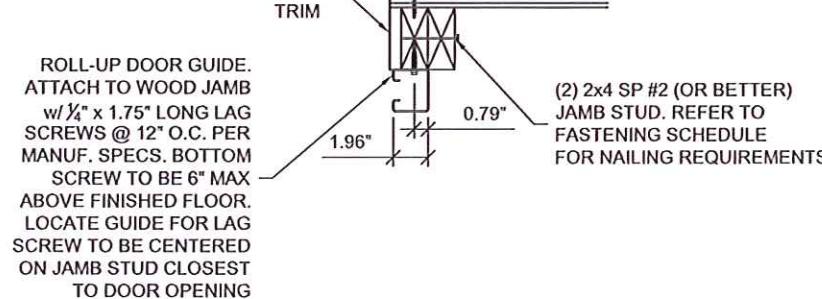

2-ROLL-UP DOOR JAMB DETAIL  
(HORIZ METAL SIDING)

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*knolan*

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90834EF600001956AF, cn=Kevin Nolan, c=US  
Date: 2023.03.22 13:58:47 -05'00'

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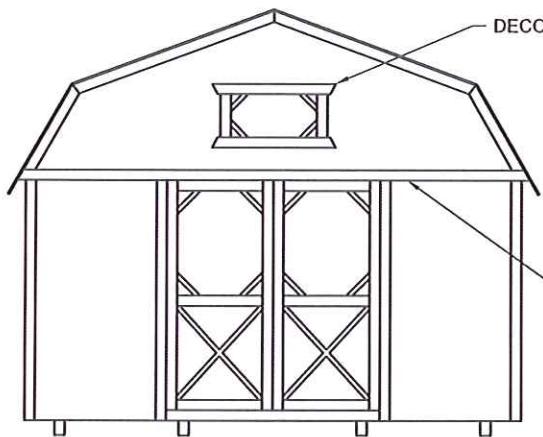
CHECKED BY: KLN

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SHEET NUMBER


**S-3.5-LB**

SCALE: 1 1/2"=1'-0




FRONT ELEVATION

DECORATIVE TRIM  
PROVIDE CONTINUOUS  
ALUMINUM Z-BAR FLASHING  
AT SIDING HORIZONTAL JOINTS.  
ATTACH TO FRAMING w/ 1"x $\frac{3}{4}$ "  
STAPLES AT 12" O.C. (TYP)

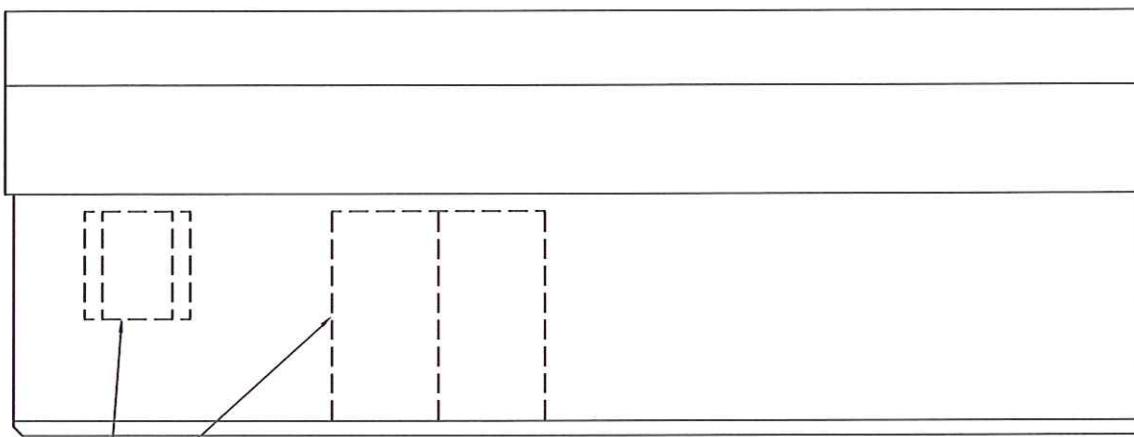

SIDE ELEVATION

DOOR AND WINDOW LOCATIONS  
VARY PER CUSTOMER.

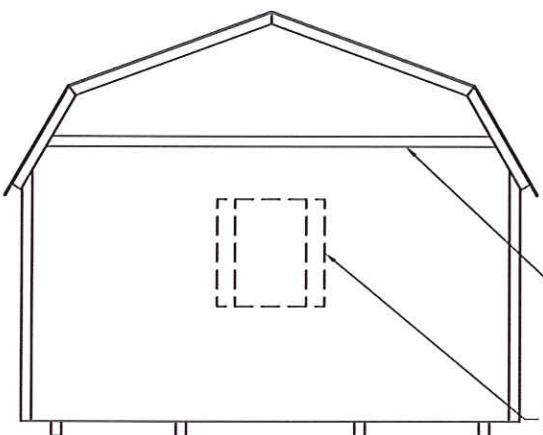

REAR ELEVATION

PROVIDE CONTINUOUS  
ALUMINUM Z-BAR FLASHING  
AT SIDING HORIZONTAL JOINTS.  
ATTACH TO FRAMING w/ 1"x $\frac{3}{4}$ "  
STAPLES AT 12" O.C. (TYP)

OPTIONAL DOOR OR WINDOW.  
LOCATIONS VARY PER CUSTOMER.

NOTE:  
WINDOWS, DOORS, AND TRIM SHOWN ARE CONCEPTUAL. ACTUAL WINDOW, DOOR, AND TRIM  
MAY VARY PER CUSTOMER REQUEST.

Approved by Phillip E Robbins  
Florida PE-49070  
*Phillip E Robbins*  
Plan No. 1RPER210076 Date: 03/27/2023

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"APPROVED"  
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Date: 2023.03.22 14:00:02 -05'00'

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DATE: 09-28-2021

DRAWN BY: KLN

CHECKED BY: KLN

REVISION:

SHEET NUMBER

**S-4-LB**

SCALE: NOT TO SCALE